GENERAL NOTES EACH CONTRACTOR SHALL VERIFY AND COORDINATE ALL NEW AND EXISTING CONDITIONS AND DIMENSIONS AT JOB SITE FOR COMPARISON WITH DRAWINGS AND SPECIFICATIONS PRIOR TO BIDDING AND AT THE START OF AND DURING CONSTRUCTION. IF ANY

DISCREPANCIES, INCONSISTENCIES OR OMISSIONS ARE FOUND, THE ARCHITECT SHALL BE NOTIFIED IN WRITING FOR CLARIFICATION PRIOR TO PROCEEDING WITH WORK. ALL WORK SHALL COMPLY WITH FEDERAL, STATE, AND LOCAL CODES AND REGULATORY AGENCIES HAVING JURISDICTION IN THIS AREA. IF THE CONTRACTOR ASCERTAINS AT ANY TIME THAT REQUIREMENTS OF THIS CONTRACT CONFLICT WITH, OR ARE IN VIOLATION OF, APPLICABLE LAWS, CODES, REGULATIONS AND ORDINANCES, HE SHAL NOT PROCEED WITH WORK IN QUESTION, EXCEPT AT HIS OWN RISK, UNTIL THE ARCHITECT HAS BEEN NOTIFIED IN WRITING AND WRITTEN DETERMINATION IS MADE BY THE ARCHITECT. WHERE COMPLETED OR PARTIALLY COMPLETED WORK IS DISCOVERED TO BE IN VIOLATION WITH APPLICABLE LAWS, CODES, REGULATIONS AND ORDINANCES, THE CONTRACTOR SHALL BE REQUIRED TO REMOVE THAT WORK FROM THE PROJECT AND REPLACE SUCH WORK WITH ALL NEW COMPLYING WORK AT NO ADDITIONAL COST

TO THE OWNER OR ARCHITECT. ALL SECTIONS, DETAILS, MATERIALS, AND METHODS SHOWN AND / OR NOTED ON ANY SHEET SHALL APPLY TO ALL OTHER SIMILAR LOCATIONS UNLESS NOTED OTHERWISE. NO CONTRACTOR HAS THE AUTHORITY TO PERMIT THE USE OF ANY PORTION OF THE SITE

OR BUILDING TO ANYONE, EXCEPT FOR BUSINESS CONNECTED TO THE CONSTRUCTION

WITH WHICH THIS CONTRACT IS CONCERNED DIMENSIONS SHOWN ON FLOOR PLANS ARE TO FINISH FACE OF STUD, MASONRY OR CONCRETE TO FACE OF STUD, MASONRY, AND CONCRETE OR GRIDLINES UNLESS

DO NOT SCALE DRAWINGS. CONTRACTOR SHALL RELY ON WRITTEN DIMENSIONS AS GIVEN. THE CONTRACTOR SHALL NOTIFY THE ARCHITECT FOR CLARIFICATIONS ALL DIMENSIONS SHALL BE FIELD VERIFIED BY CONTRACTOR AND COORDINATED WITH ALL OF THE WORK OF ALL TRADES. IF DISCREPANCIES ARE FOUND, THE CONTRACTOR SHALL NOTIFY THE ARCHITECT IN WRITING FOR CLARIFICATION BEFORE THE COMMENCEMENT OR RESUMPTION OF WORK.

ABBREVIATIONS THROUGHOUT THE PLANS ARE THOSE IN COMMON USE. NOTIFY THE ARCHITECT OF ANY ABBREVIATIONS IN QUESTION. THE CONTRACTOR AND SUBCONTRACTORS SHALL BE RESPONSIBLE FOR OBTAINING AND PAYING FOR ALL PERMITS. DESIGN REVIEW FEES, AND ALL OTHER FEES, AND

INSPECTIONS REQUIRED BY LOCAL STATE AND FEDERAL AGENCIES FINISH FLOOR ELEVATIONS ARE AS ESTABLISHED DATUM LINE, UNLESS OTHERWISE NOTED. THE CONTRACTOR SHALL FURNISH ALL MATERIALS, LABOR, EQUIPMENT, TRANSPORTATION AND SERVICE NECESSARY FOR THE SATISFACTORY COMPLETION OF WORK UNLESS DESIGNATED (N.I.C.) OR (O.F.O.I.). ALL EQUIPMENT, WORK AND MATERIALS SHALL COMPLY WITH ALL CURRENT AND LOCAL APPLICABLE CODES AND GOVERNING REGULATIONS AND THE CONTRACT DOCUMENTS.

THE CONTRACTOR'S SHALL BE RESPONSIBILITY FOR COORDINATION WITH THE ARCHITECTURAL, STRUCTURAL, PLUMBING AND ELECTRICAL DRAWINGS BEFORE THE INSTALLATION OF ANY OF THE CONSULTANT'S WORK AND TO BRING ANY DISCREPANCIES OR CONFLICTS TO THE ARCHITECT'S ATTENTION IN WRITING FOR CLARIFICATION IMPROPERLY INSTALLED WORK SHALL BE CORRECTED BY THE CONTRACTOR AT HIS EXPENSE AND AT NO EXPENSE TO THE ARCHITECT, HIS CONSULTANTS OR THE OWNER.

IN THE CASE OF A CONFLICT BETWEEN THE DRAWINGS AND THE SPECIFICATIONS SPECIFICATIONS SHALL TAKE PRECEDENCE. CONTRACTOR SHALL NOTIFY THE ARCHITECT OF ANY CONFLICT BEFORE PROCEEDING WITH THE WORK. ANY WORK INSTALLED IN CONFLICT WITH THE CONTRACT DOCUMENTS SHALL BE

TO THE OWNER. ARCHITECT OR CONSULTANTS. CONTRACTORS PERFORMING WORK ON THE PREMISES SHALL BE RESPONSIBLE FOR INITIATING, MAINTAINING AND SUPERVISING A REASONABLE AND PRUDENT SAFETY PROGRAM INCLUDING BUT NOT LIMITED TO THE ISOLATION OF WORK AREAS AND THE PROMPT REMOVAL OF ANY DEBRIS OR TOOLS, WHICH MIGHT ENDANGER VISITORS, AND STAFF OF THE OWNER OR ARCHITECT

CORRECTED BY THE CONTRACTOR AT HIS EXPENSE AND AT NO ADDITIONAL EXPENSE

ALL TRENCHES OR EXCAVATIONS IN EXCESS OF 5' IN DEPTH INTO WHICH A PERSON IS REQUIRED TO DESCEND, SHALL COMPLY WITH ALL OSHA, STATE AND LOCAL

THE CONTRACTOR SHALL PROVIDE AND INSTALL ALL STIFFENERS, BRACINGS, BACK-UP PLATES AND SUPPORTING BRACKETS REQUIRED FOR THE INSTALLATION OF ALL CASEWORK, TOILET ACCESSORIES AND OF ALL FLOOR-MOUNTED OR CEILING SUSPENDED EQUIPMENT. ALL WOOD BLOCKING / NAILERS SHALL BE PRESSURE

TREATED WHEN IN CONTACT WITH CONCRETE OR MASONRY. CONTRACTOR SHALL COORDINATE THE INSTALLATION OF THE VARIOUS TRADE ITEMS WITHIN THE SPACE ABOVE ALL CEILINGS (INCLUDING, BUT NOT LIMITED TO: STRUCTURAL MEMBERS, MECHANICAL DUCTS AND INSULATION, CONDUITS, RACEWAYS, SPRINKLER SYSTEM LIGHT FIXTURES CEILING SYSTEMS AND ANY SPECIAL STRUCTURAL SUPPORTS REQUIRED) AND SHALL BE RESPONSIBLE FOR MAINTAINING THE FINISH CEILING HEIGHT ABOVE THE FINISH FLOOR INDICATED IN THE DRAWINGS AND THE FINISH SCHEDULE. (CEILING HEIGHT DIMENSIONS ARE TO THE FINISH SURFACE OF

ACCESS PANELS SHALL BE PROVIDED AND INSTALLED WHEREVER REQUIRED BY THE BUILDING CODE OR FOR THE PROPER OPERATION OR MAINTENANCE OF MECHANICAL OR ELECTRICAL EQUIPMENT, WHETHER OR NOT INDICATED ON THE DRAWINGS. THE CONTRACTOR SHALL COORDINATE SIZE LOCATION AND TYPE OF ACCESS PANEL WITH OTHER CONTRACTOR'S WORK AND SHALL RECEIVE APPROVAL FROM THE ARCHITECT. NO ACCESS PANEL SHALL BE LOCATED, FRAMED OR INSTALLED WITHOUT THE

EXPRESSED APPROVAL OF THE ARCHITECT WHEN IT IS NECESSARY TO INTERRUPT ANY EXISTING UTILITY SERVICE TO MAKE CORRECTION AND/OR CONNECTION, A MINIMUM OF 48 HOURS ADVANCE NOTICE SHALL BE GIVEN TO THE OWNER AND UTILITY COMPANY. INTERRUPTIONS IN UTILITY SERVICES SHALL BE OF THE SHORTEST POSSIBLE DURATION FOR THE WORK AT HAND AND SHALL BE APPROVED IN ADVANCE BY THE OWNER AND UTILITY COMPANY. IN THE EVENT THE UTILITY SERVICE IS INTERRUPTED WITHOUT THE REQUIRED 48 HOURS' NOTICE, THEN THE CONTRACTOR SHALL BE FINANCIALLY LIABLE FOR ALL DAMAGES SUFFERED BY THE OWNER DUE TO THE UNAUTHORIZED INTERRUPTION. RECONNECTION SHALL BE MADE

THE CONTRACTOR SHALL COORDINATE WITH REPRESENTATIVES OF WATER, ELECTRICAL, GAS, TELEPHONE AND CABLE TELEVISION COMPANIES TO VERIFY AVAILABLE FACILITIES AND IF APPLICABLE TO ESTABLISH TEMPORARY FACILITIES.

THE CONTRACTOR SHALL VERIFY THE LOCATION OF ALL EXISTING UTILITIES BELOW GRADE AND RELATED SERVICES CONNECTIONS WITH THE RESPECTIVE UTILITY COMPANIES. THE CONTRACTOR SHALL COORDINATE THE REMOVAL, ABANDONMENT, AND OR RELOCATION OF EXISTING UTILITIES ABOVE OR BELOW GRADE WITH THE RESPECTIVE

THE CONTRACTOR SHALL PROVIDE TEMPORARY PEDESTRIAN PROTECTION AS REQUIRED BY OSHA AND LOCAL CODE WHERE THE CONSTRUCTION ENCROACHES A PEDESTRIAN

THE CONTRACTOR SHALL PROVIDE SANITARY FACILITIES FOR WORKERS USE. EXISTING

FACILITIES SHALL NOT BE USED. ONLY NEW MATERIALS AND EQUIPMENT OF RECENT MANUFACTURE, OF QUALITY SPECIFIED, FREE FROM DEFECTS, WILL BE PERMITTED ON THE WORK.

THE CONTRACTOR SHALL PROTECT ALL FINISH WORK AND SURFACES FROM DAMAGE DURING COURSE OF CONSTRUCTION AND SHALL REPLACE AND OR REPAIR ALL DAMAGED SURFACES CAUSED BY CONTRACTOR OR SUBCONTRACTOR PERSONNEL TO THE SATISFACTION OF THE OWNER AND ARCHITECT.

CLEAN UP AND DISPOSAL: REMOVE DEBRIS, RUBBISH AND WASTE MATERIAL FROM THE OWNER'S PROPERTY TO A LAWFUL DISPOSAL AREA AND PAY ALL HAULING AND DUMPING COSTS, CONFORM TO PERTAINING FEDERAL STATE AND LOCAL LAWS, REGULATION AND ORDERS. UPON COMPLETION OF WORK, ALL CONSTRUCTION AREAS SHALL BE LEFT VACUUM-CLEAN AND FREE FROM DEBRIS. CLEAN ALL DUST, DIRT. STAINS, HAND MARKS, PAINT SPOTS, DROPPINGS, AND OTHER BLEMISHES.

REFERENCE TO MAKERS, BRAND, MODELS, ETC. IS TO ESTABLISH THE TYPE AND QUALITY DESIRED: SUBSTITUTION OF ACCEPTABLE EQUIVALENTS WILL BE PERMITTED IF APPROVED BY THE ARCHITECT AND OWNER PRIOR TO BID (UNLESS NOTED

THE ARCHITECT, ACTING AS THE OWNER'S DESIGNATED AGENT FOR THE DESIGN FOR THIS PROJECT WILL EXERCISE SOLE AUTHORITY FOR DETERMINING CONFORMANCE OF MATERIALS, EQUIPMENT AND SYSTEMS WITH INTENT OF THE DESIGN. INSTALLATION OF FIRE ALARM SYSTEM, AUTOMATIC FIRE SPRINKLER SYSTEM AND

STANDPIPE SYSTEM SHALL NOT BE STARTED UNTIL DETAIL PLANS, SPECIFICATIONS AND ENGINEERING CALCULATIONS HAVE BEEN ACCEPTED BY THE ARCHITECT AND OR PROFESSIONAL ENGINEER WHO HAS RESPONSIBILITY COVERING THE WORK SHOWN ON PLANS OR SPECIFICATION AND APPROVED BY STATE AND LOCAL AUTHORITIES. SHOP DRAWING SENT TO THE ARCHITECT THAT HAVE NOT BEEN REVIEWED BY THE CONTRACTOR AND NOT BEARING THE SHOP DRAWING STAMP AND SIGNATURE OF THE

CONTRACTOR WILL BE RETURNED TO THE CONCENTRATOR NOT REVIEWED. SHOP DRAWINGS SHALL BE SUBMITTED FOR ALL EQUIPMENT AND MATERIALS WHICH MUST INTERFACE AND COORDINATE WITH OTHERS, WHETHER DETAILED OR NOT. SHOP DRAWINGS SHALL BE SUBMITTED IN A MINIMUM OF 3 COPIES AND ONE TRANSPARENCY: BROCHURES IN NOT LESS THAN 4 COPIES. TEMPORARY FACILITIES:

THE CONTRACTOR SHALL PROVIDE A STAGING AND MATERIAL STORAGE AREA OF CONSTRUCTION. LOCATION SHALL BE COORDINATED WITH THE OWNER. THE CONTRACTOR SHALL MAKE NECESSARY CONNECTIONS TO EXISTING UTILITIES FOR TEMPORARY POWER AND WATER SUPPLIES, AND SHALL COORDINATE SUCH USE WITH THE OWNER PRIOR TO CONNECTION. THE CONTRACTOR SHALL PROVIDE TEMPORARY BARRICADES TO SEPARATE

CONSTRUCTION AREAS FOR PUBLIC SAFETY AROUND ENTIRE PERIMETER OF THE CONTRACTOR SHALL PROVIDE A BLANKET ONE (1) YEAR GUARANTEE OF THE CONTRACT PROJECT WITH SEPARATE GUARANTEES AS SPECIFIED FOR TRADES/EQUIPMENT ITEMS WITH NAMES OF LOCAL REPRESENTATIVES TO BE

CONTACTED FOR SERVICE PROVIDE OPERATING MAINTENANCE BROCHURES AND GUARANTEES AS REQUIRED THE CONTRACTOR SHALL PROVIDE ONE COMPLETE SET OF AS-BUILT DRAWINGS INDICATING ALL DISCREPANCIES, CHANGES, ETC. AND ACTUAL LOCATIONS OF CONCEALED WORK TO THE OWNER AT THE COMPLETION OF WORK PRIOR TO FINAL PAYMENT. CHANGES MUST BE SHOWN ON A CLEAN SET OF CONSTRUCTION DRAWINGS

JOHNSON REALTY

1000 West New Circle Road Lexington, Kentucky



DRAWING INDEX

CVR COVER SHEET C100 SITE PLAN

EX100 EXISTING FLOOR PLAN

D100 DEMOLITION PLAN A100 FLOOR PLANS

A101 FLOOR PLANS A102 FLOOR PLANS

A110 ROOF PLAN A200 REFLECTED CEILING PLAN

A201 REFLECTED CEILING PLAN A202 REFLECTED CEILING PLAN

A300 EXTERIOR ELEVATIONS A301 EXTERIOR ELEVATIONS

A400 WALL SECTIONS A401 WALL SECTIONS

A500 DOOR SCHEDULE AND DETAILS

A501 DETAILS

APPLICABLE BUILDING CODE:

2015 INTERNATIONAL BUILDING CODE 2018 KENTUCKY BUILDING CODE 2015 INTERNATIONAL MECHANICAL CODE 2009 ENERGY CONSERVATION CODE 2013 KENTUCKY PLUMBING CODE NFPA 70 NATIONAL ELECTRICAL CODE ICC 117.1-2009 ANSI ACCESSIBLE STANDARDS

USE GROUP CLASSIFICATION / OCCUPANCY: S-1 MODERATE-HAZARD STORAGE

BUILDING OCCUPANCY:

AREA USE STORAGE 1:300 S F 25,897 S F TOTAL OCCUPANCY

CODE REVIEW DATA

CONSTRUCTION CLASSIFICATION: II-B NON COMBUSTIBLE UNPROTECTED ALLOWABLE BUILDING AREA

> BASE AREA FROM TABLE 506.2 00,000 S F OPEN PERIMETER INCREASE 506.3 00,000 S F TOTAL: 00,000 S F

ACTUAL BUILDING AREA:

8,447 S F **ADDITIONS** 20,025 S F TOTAL: 28,472 S F

1 STORY 22'-7" FT

ALLOWABLE BUILDING HEIGHT: * USE GROUP (TABLE 504.3 AND 504.4) 2 STORIES 55 FT

ACTUAL BUILDING HEIGHT:

FIRE SUPPRESSION:

THE ENTIRE BUILDING SHALL BE PROTECTED WITH A SPRINKLER SYSTEM IN ACCORDANCE WITH KENTUCKY BUILDING CODE 907 AND NFPA 13.

SPECIAL INSPECTIONS:

PROVIDE SPECIAL INSPECTIONS AS REQUIRED BY KBC 2018 CHAPTER 1 AND SECTION 1704.

SEE STRUCTURAL GENERAL NOTES

CONTRACTOR SHALL PROVIDE SUMMARY REPORTS OF SPECIAL INSPECTIONS AT COMPLETION OF PROJECT. THE FINAL LETTER SHALL INDICATE ALL INSPECTIONS THAT WERE COMPLETED, BY WHOM, RESULTS, AND CORRECTION OF ANY DISCREPANCIES NOTED IN THE INSPECTIONS. REPORTS SHALL BE SUBMITTED TO THE OWNER, THE ARCHITECT AND DESIGN PROFESSIONAL REQUESTING THE SPECIAL INSPECTION (SECTION 1704.1.2, 2013

Jerry Herndon Architect

ARCHITECT

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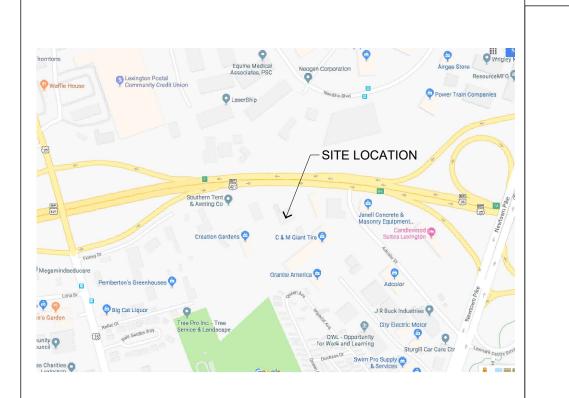
F: 859.225.0360

CONSULTANTS

Ronnie Johnson

OWNER

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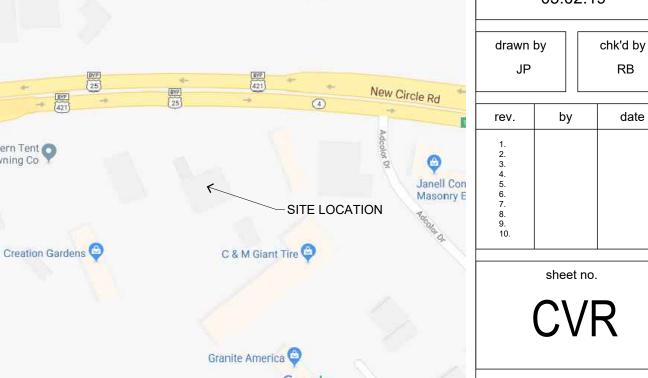


VICINITY MAP

LOCATION MAP


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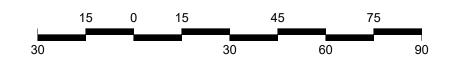
COVER SHEET



Jerry W. Herndon, Architect©2017

IN RED INK



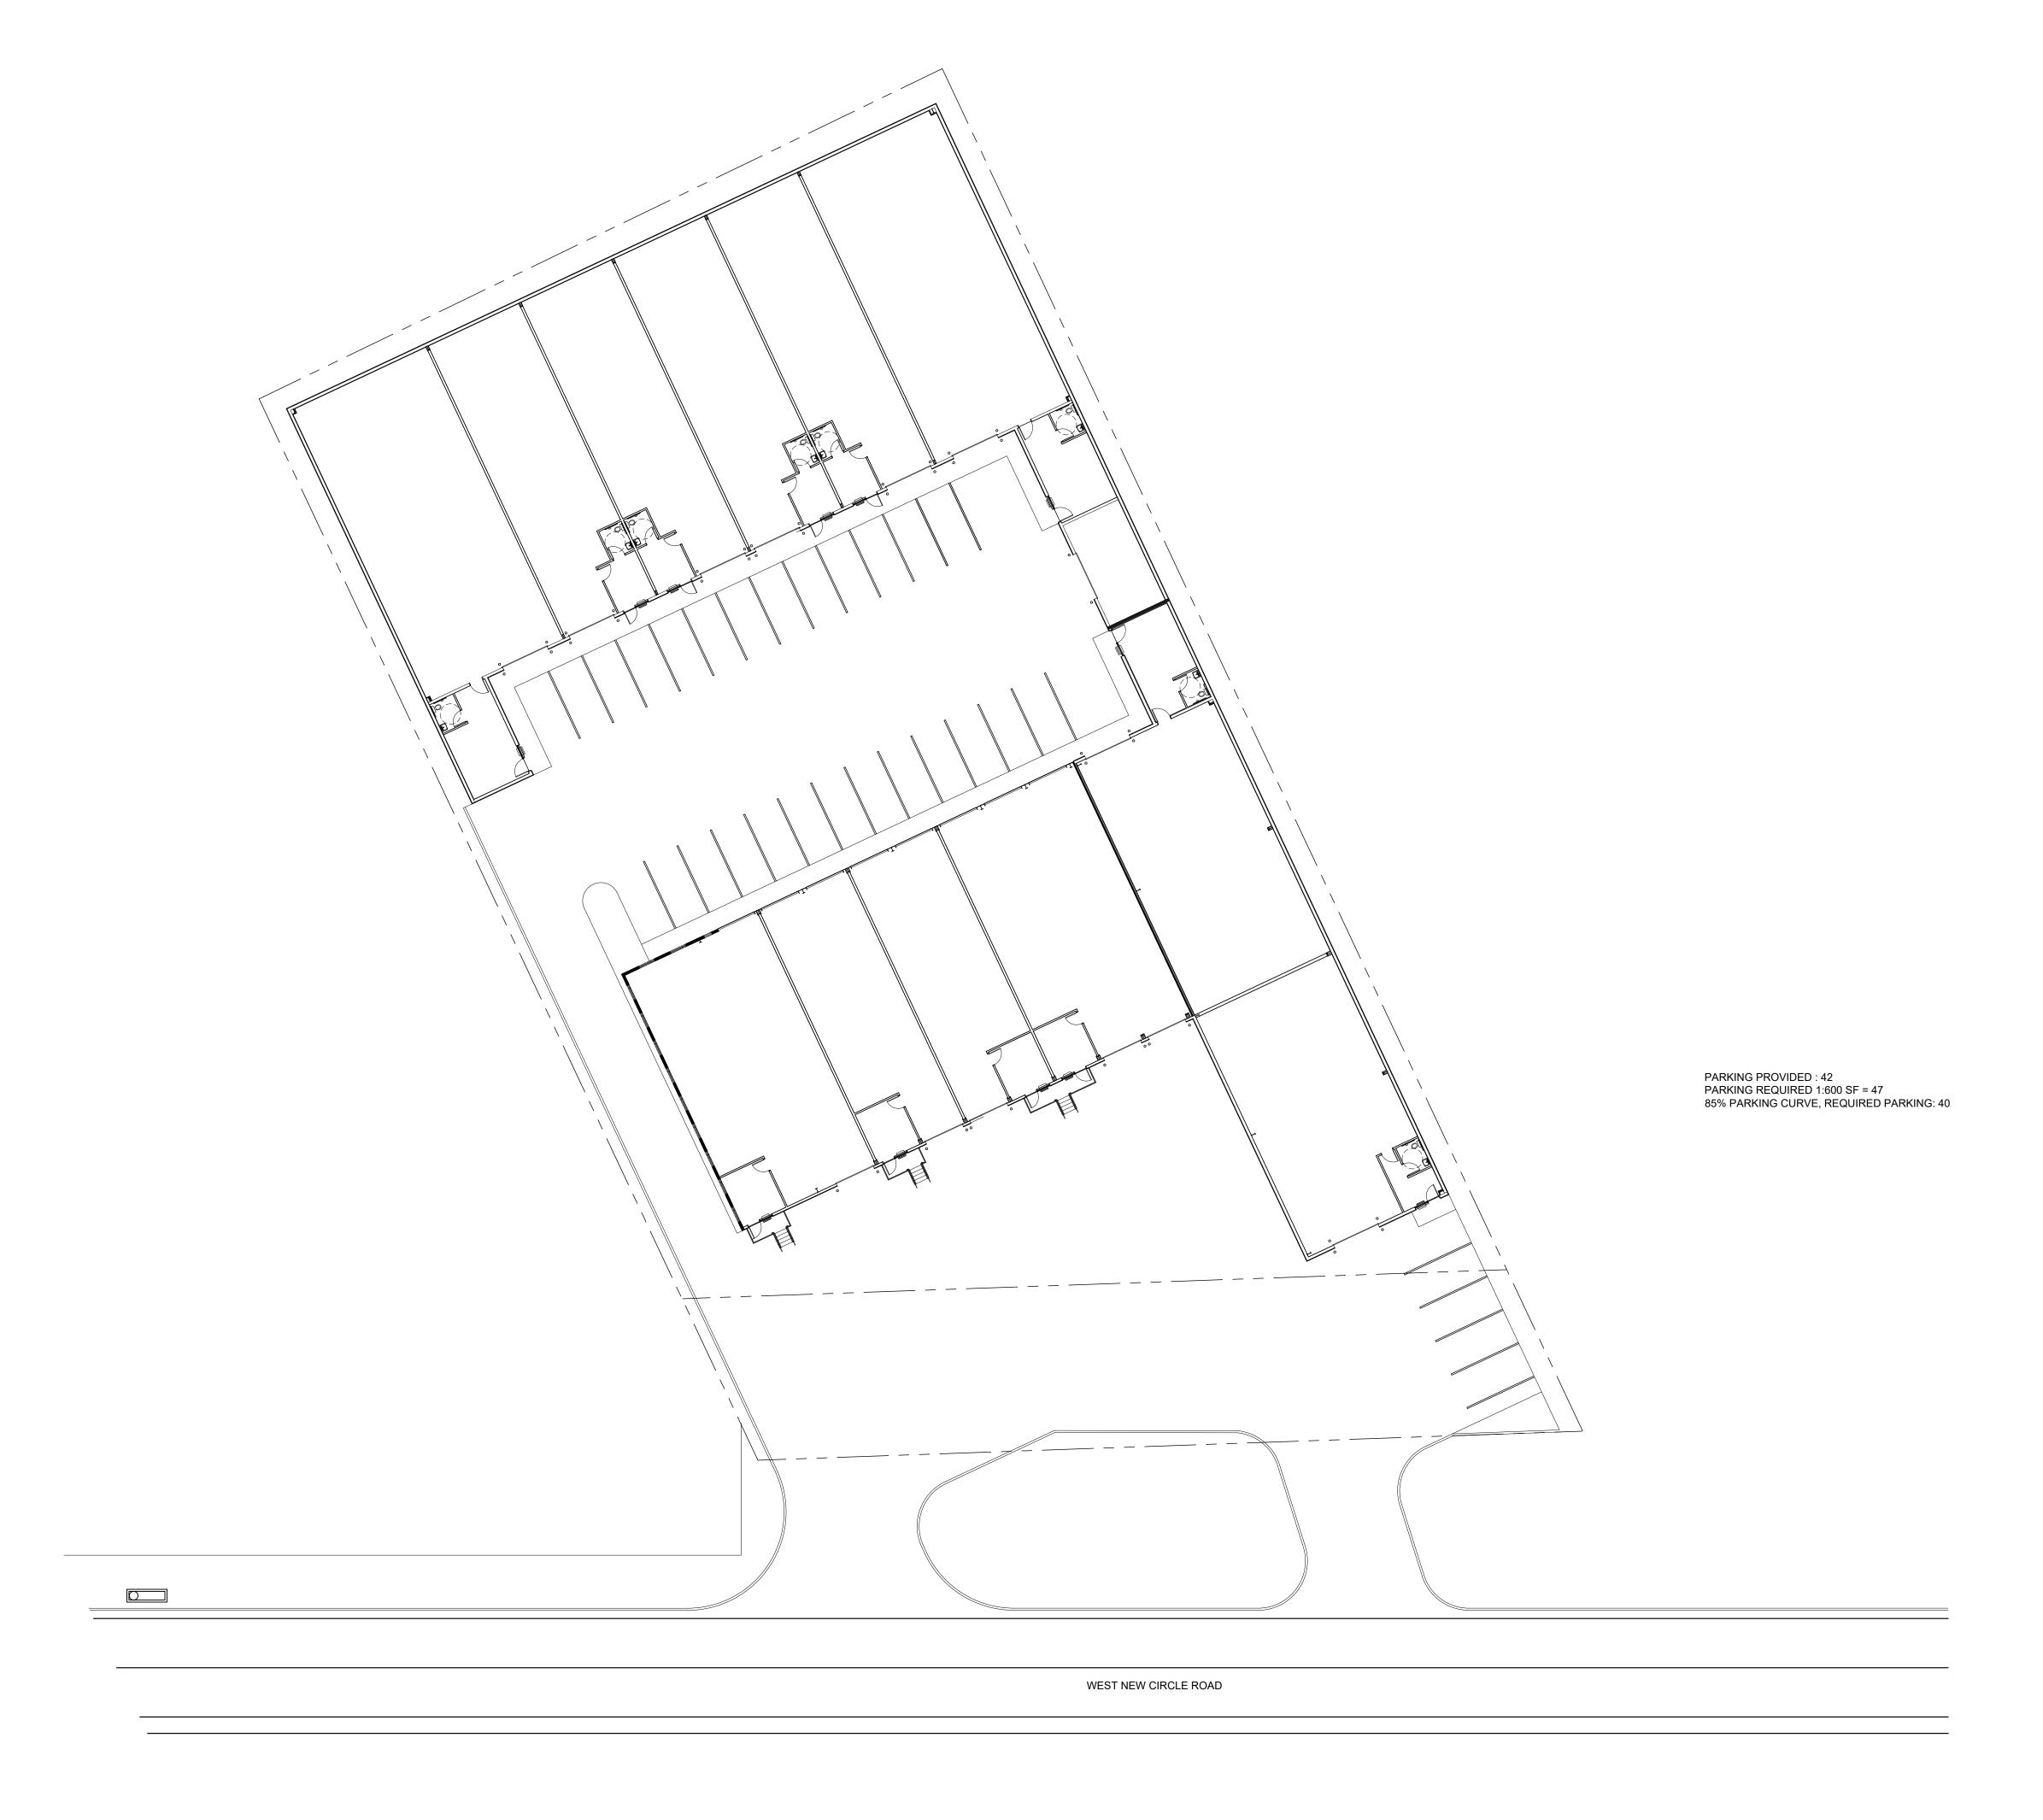

SITE PLAN | 1" = 20' :SCALE

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ITE PLAN

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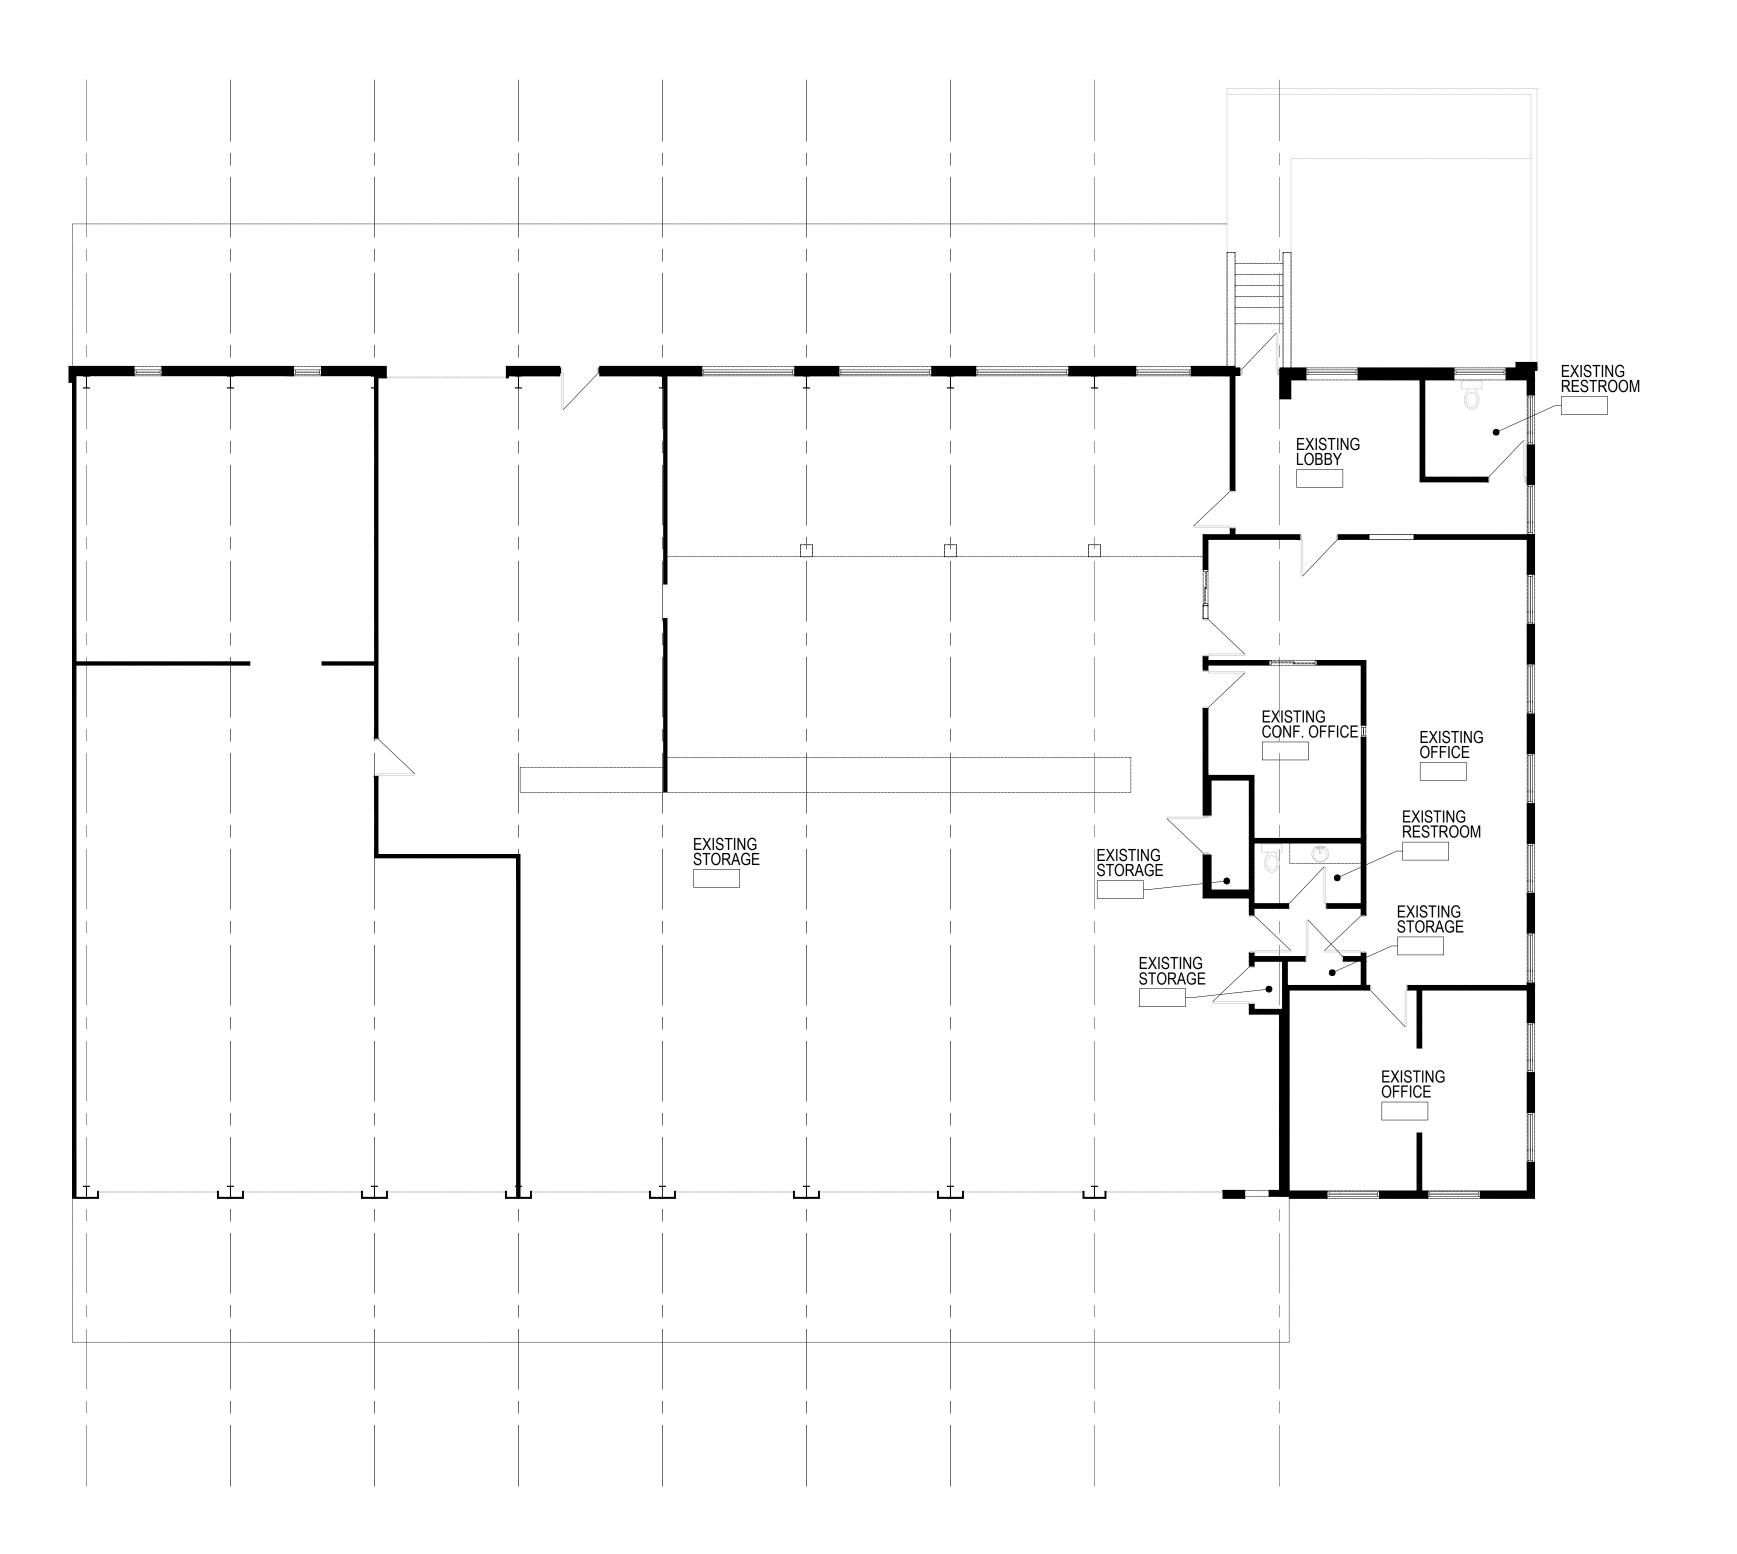
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EXISTING FLOOR PLAN

project no.

date 03.10.20

drawn by chk'd by


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EXISTING FLOOR PLAN



GENERAL NOTES DEMO

DEMOLITION KEY NOTES ARE GENERAL FOR SPECIFIC AREAS AND MAY NOT COVER ALL DEMOLITION WORK REQUIRED. THE CONTRACTOR IS RESPONSIBLE FOR ALL WORK, REQUIRED TO COMPLETE THE DEMOLITION WORK WHETHER SPECIFICALLY INDICATED OF NOT.

THIS DEMOLITION PLAN/DRAWING WAS CREATED FROM EXISTING WORKING DRAWINGS AND ARE INTENDED TO SHOW THE GENERAL CONDITION WHICH IS EXPECTED TO OCCUR. THE CONTRACTOR SHALL VERIFY ALL CONDITIONS BEFORE PROCEEDING WITH THE DEMOLITION WORK IN ANY AREA. DEMOLITION OF DOORS, WINDOWS, CABINETRY, FINISHES, PARTITIONS, OR ANY OTHER NONSTRUCTURAL ITEMS MAY PROCEED AS INDICATED. WHERE DISCREPANCIES INVOLVE STRUCTURAL ITEMS, REPORT SUCH DIFFERENCES TO THE ARCHITECT AND SECURE INSTRUCTIONS BEFORE PROCEEDING IN THE AFFECTED AREA.

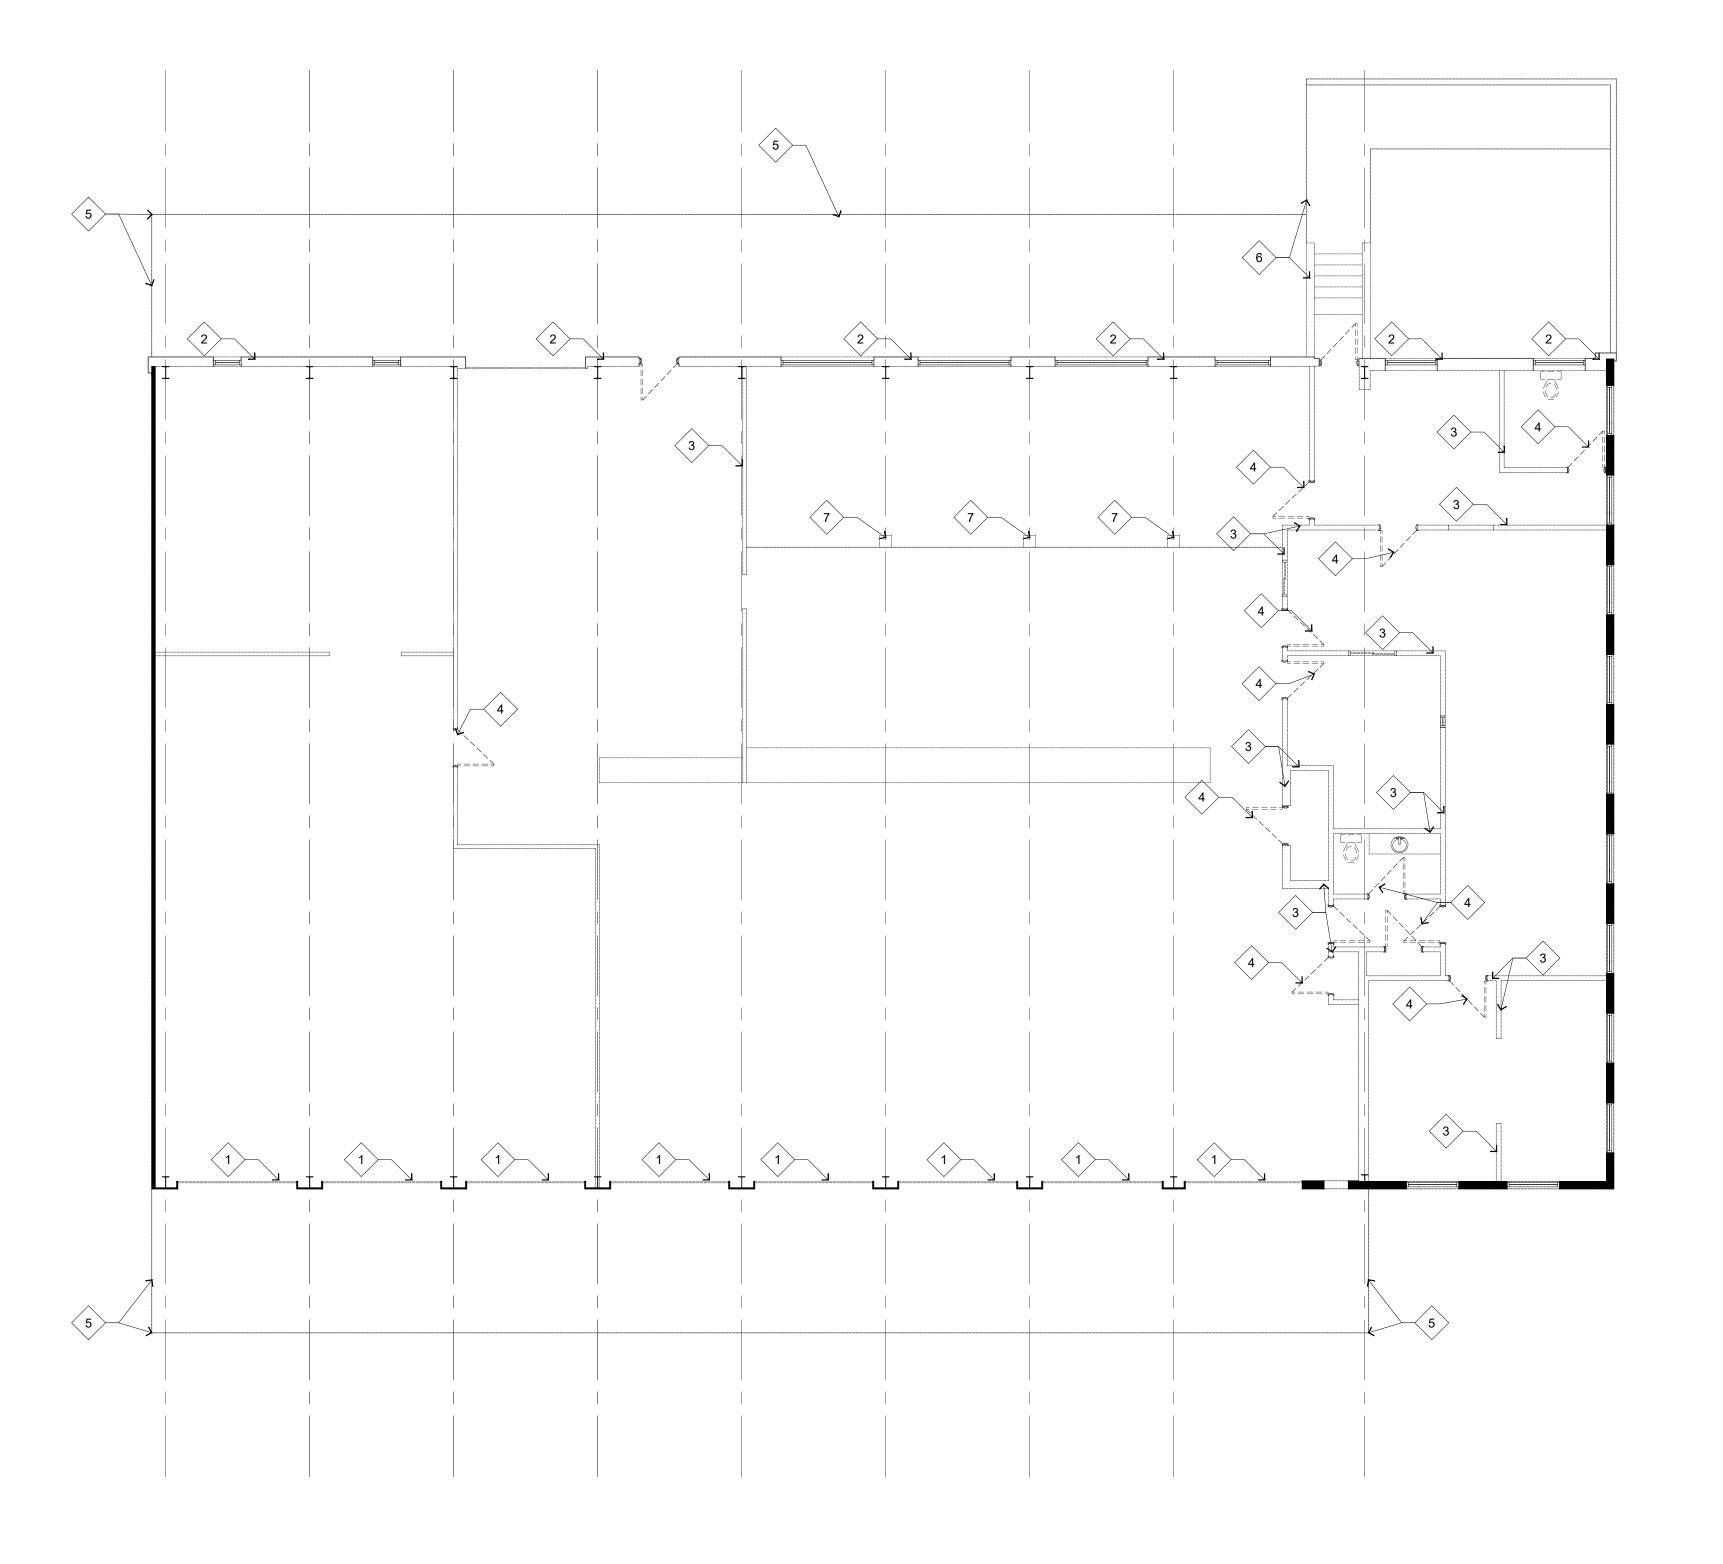THE CONSTRUCTOR SHALL COORDINATE WITH THE OWNER'S REPRESENTATIVE THE SALVAGE OF REUSABLE BUILDING FIXTURES, MATERIALS, FURNISHINGS, DOORS, AND MISCELLANEOUS EQUIPMENT.

THE CONTRACTOR SHALL REMOVE EXISTING WALLS AND OTHER ASSOCIATED CONSTRUCTION AS INDICATED ON THE DEMOLITION PLANS WITH DASHED LINES.

REFER TO MECHANICAL AND ELECTRICAL DRAWINGS FOR ADDITIONAL DEMOLITION NOTES AND INFORMATION.

THE CONTRACTOR SHALL PROVIDE ALL NECESSARY BARRICADES AND OTHER FORMS OF PROTECTION AS REQUIRED TO PROTECT THE OWNER'S PERSONNEL, OTHER TENANTS AND THE GENERAL PUBLIC FROM INJURY DUE TO DEMOLITION WORK. THE CONTRACTOR SHALL COMPLY WITH OSHA STANDARDS AND COMMON PRACTICE TO ENSURE PROTECTION OF ALL PEOPLE IN THE AREA OF WORK.

THE CONTRACTOR SHALL ENSURE THAT DEMOLITION WORK DOES NOT INTERFERE WITH OR PROHIBIT THE CONTINUING OCCUPATION OF ADJACENT OPERATIONS WITHIN THE STRUCTURE. THIS INCLUDES BUT IS NOT LIMITED TO THE SELECTIVE DEMOLITION OF PARTITIONS, ELECTRICAL AND MECHANICAL SYSTEMS. THE CONTRACTOR SHALL INFORM THE OWNER OF A MINIMUM OF 72 HOURS OF DEMOLITION ACTIVITIES THAT WILL AFFECTIVE NORMAL OPERATION OF BUILDING. THE CONTRACTOR SHALL REPAIR DAMAGES CAUSED TO ADJACENT FACILITIES BY DEMOLITION WORK.

THE CONTRACTOR SHALL CONSULT WITH A STRUCTURAL ENGINEER PRIOR TO CUTTING INTO ANY STRUCTURAL ELEMENT OF THE BUILDING. THE CONTRACTOR SHALL BE RESPONSIBLE FOR ALL REINFORCING, SHORING AND SUPPORT TO MAINTAIN THE STRUCTURAL INTEGRITY OF THE BUILDING.


PRIOR TO INSPECTION OF THE EXISTING FACILITY, THE CONTRACTOR MUST RECEIVE PERMISSION FOR SITE ACCESS FORM THE OWNER OR THE DESIGNATED REPRESENTATIVE.

AT ALL AREAS OF DEMOLITION AND NEW CONSTRUCTION; THE CONTRACTOR SHALL PATCH AND REFINISH EXISTING WALLS, FLOORS, AND CEILINGS AS REQUIRED TO MATCH ADJACENT MATERIALS AND FINISHES.

REMOVE DEBRIS, RUBBISH AND OTHER BUILDING MATERIALS NOT TO BE REUSED FROM THE SITE ON A REGULAR BASIS. TRANSPORT AND LEGALLY DISPOSE OF MATERIALS OFF SITE.

IF HAZARDOUS MATERIALS ARE ENCOUNTERED DURING DEMOLITION THE CONTRACTOR SHALL STOP WORK IN THAT AREA, CONTACT THE OWNERS REPRESENTATIVE AND THE ARCHITECT FOR ADDITIONAL INSTRUCTIONS BEFORE PROCEEDING WITH ANY ADDITIONAL WORK IN THAT AREA.



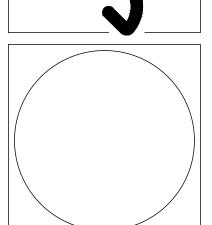

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- 1. REMOVE EXISTING OVERHEAD DOOR & CLOSE OPENING WITH 6" METAL STUDS W/ 5/8' GYPSUM BOARD AND 1 1/2" METAL SIDING MATCH
- 2. REMOVE THE ENTIRETY OF THE EXTERIOR NORTH FACE DOWN THE THE MAINFRAME.

SHEET NOTES

- 3. REMOVE EXISTING WALL & ITS ENTIRETY4. REMOVE EXISTING DOOR
- 5. REMOVE EXISTING CANOPY BACK TO FACE OF EXISTING BUILDING & REFINISH REMOVED AREA
- 6. REMOVE EXISTING STAIRS AND SIDEWALK7. REMOVE EXISTING INTERIOR COLUMNS AND STORAGE SPACE ABOVE

EMOLITION


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DEMO PLAN 1/8" = 1'-0" :SCALE



FLOOR PLAN

1/8" = 1'-0" :SCALE

GENERAL NOTES FLOOR PLAN

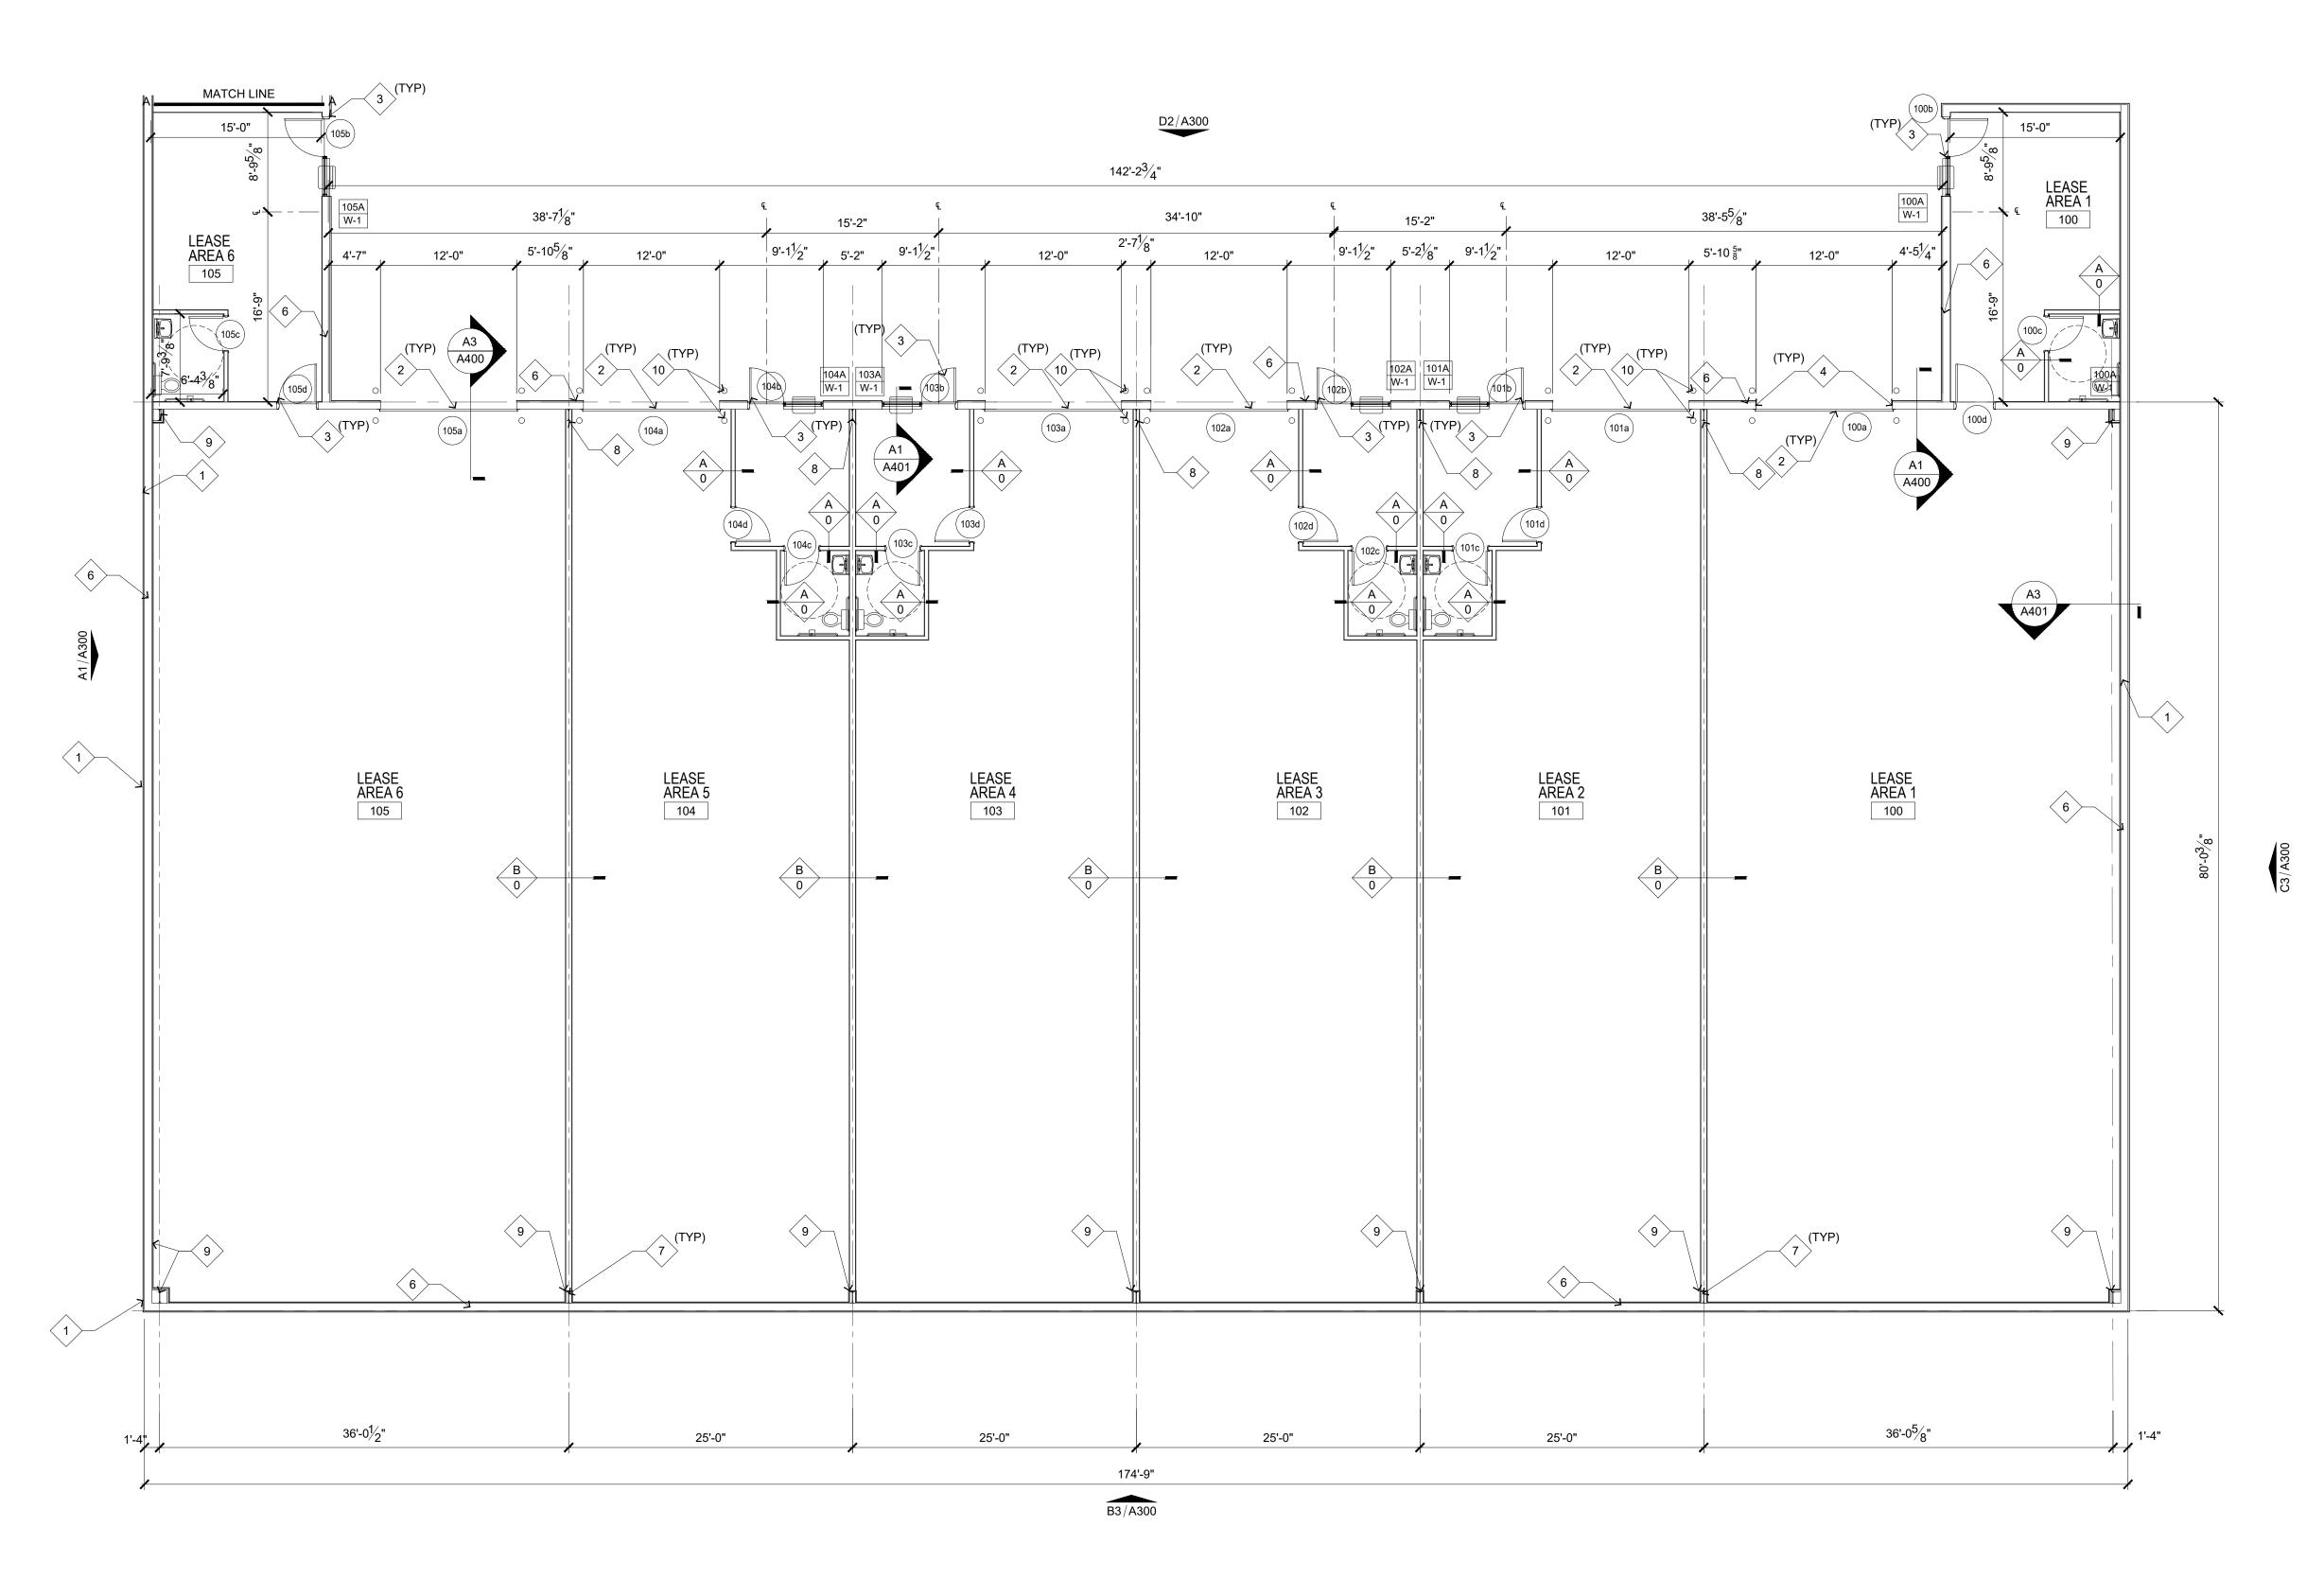ALL DIMENSIONS ARE FROM/TO FACE OF METAL STUDS/MASONRY TO FACE OF METAL STUDS/MASONRY U N O.

DO NOT SCALE DRAWINGS IF DIMENSIONS ARE IN QUESTION, THE CONTRACTOR SHALL BE RESPONSIBLE FOR OBTAINING CLARIFICATION FROM THE ARCHITECT BEFORE CONTINUING WITH CONSTRUCTION. THE CONTRACTOR SHALL VERIFY ALL DIMENSIONS AND CONDITIONS AT THE SITE AND REPORT ANY DISCREPANCY TO THE ARCHITECT/OWNERS REPRESENTATIVE BEFORE PROCEED WITH THE WORK.

ALL SECTIONS, DETAILS, MATERIALS, METHODS, ETC SHOWN AND/OR NOTED ON ANY PLAN OR SECTION SHALL APPLY TO ALL OTHER SIMILAR CONDITIONS AND LOCATIONS UNLESS NOTED OTHERWISE.

ALL EXTERIOR WALL METAL STUDS SHALL BE 8" - 16 GAUGE METAL STUDS @ 16"

ALL INTERIOR METAL STUDS SHALL BE 3 5/8" @ 24" O. C. U. N. O. SEE GAUGE GUIDE BELOW & WALL TYPE'S LEGEND THIS SHEET. ALL GYPSUM WALL BOARD SHALL BE 5/8" PROVIDE FIRE CODE WHERE NOTED OR

AND AS RECOMMENDED BY USG CONSTRUCTION HANDBOOK AND COMMON

INDICATED BY WALL TYPES. PROVIDE GYPSUM BOARD CONTROL JOINTS IN INTERIOR WALL, COORDINATE LOCATION OF INTERIOR CONTROL JOINTS WITH JOINTS IN EXTERIOR WALL

THE CONTRACTOR SHALL PROVIDE WOOD BLOCKING FOR ALL WALL MOUNTED ACCESSORIES.

GYPSUM WALL BOARD ON REST ROOM WET WALLS SHALL BE WATER RESISTANT GYPSUM WALL BOARD.

CONCEAL ALL PIPING IN WALLS. WHERE PIPING WILL NOT FIT IN WALL CAVITY FUR OUT WALL MINIMUM TO CONCEAL PIPING. REFER TO DOOR SCHEDULE, DETAILS AND SPECIFICATIONS FOR DOOR, DOOR

FRAME AND DOOR HARDWARE REQUIREMENTS. DOOR OPENINGS NOT LOCATED BY DIMENSION SHALL BE CENTERED IN WALL AS SHOWN OR LOCATED 4" FROM NEAREST WALL FINISH TO FINISH OF JAMB

OPENING UNLESS NOTED OTHERWISE. ALL WOOD IN CONTACT WITH MASONRY OR CONCRETE SHALL BE PRESSURE TREATED (PT) WITH AN APPROVED WOOD PRESERVATIVE.

REFER GENERAL NOTES ON SHEET CVR FOR ADDITIONAL NOTES. EXPOSED BATT INSULATION AND FACING IN ATTIC AND WALL CAVITY SHALL HAVE A FLAME SPREAD INDEX OF 25 OR LESS AND A SMOKE DEVELOPMENT RATING OF 450 OR LESS.

ALL DISSIMILAR METALLIC MATERIALS SHALL BE EFFECTIVELY ISOLATED FROM EACH OTHER TO PREVENT GALVANIC ACTION. REFER TO FINISH SCHEDULE FOR TYPE OF PAINT FINISHES, METAL FINISHES CEMENT FINISHES, WEATHER AND SOUND SEALANTS.

SHEET NOTES

- MBM METAL BUILDING PANELS. 2. 144" x 144" SECTIONAL METAL OVERHEAD DOOR (INSULATED).
- 3. 36" x 84" STOREFRONT DOOR. 4. PROVIDE 8" W x $\frac{1}{4}$ " THICK METAL BENT PLATE W/ 2" MIN. LEG LENGTH ON OUTSIDE FACE OF DOOR AND 4" MIN. LEG LENGTH
- NOT USED 6. 8" MBM GIRT WALL

ON DOOR ANGLE SIDE.

- 7. MBM MAIN FRAME.
- 8. WRAP METAL BUILDING MAIN FRAME W/ METAL STUDS &
- GYPSUM BOARD, EXTEND 4" ABOVE FINISH CLG. 9. EXTERIOR WALLS ADJACENT TO THE PROPERTY LINES WITHIN 5'-0" ARE TO RECEIVE 2 LAYERS OF 5%" FRT TYPE 'X' GYPSUM BOARD ON 8" METAL STUDS & $5\frac{1}{2}$ " BATT. INSULATION; MAIN FRAMES TO WRAPPED W/ 1 5/8" METAL STUDS AND 2 LAYERS OF
- 5/8" FRT TYPE 'X' GYPSUM BOARD. EXTEND TO ROOF DECK. 10. 6" Ø METAL PIPE BOLLARD FILL WITH CONCRETE REFER DETAIL A6/A412 PAINT SAFETY YELLOW

METAL STUD GAUGE GUIDE

(GAUGE GUIDE IS FOR INTERIOR PARTITIONS ONLY)

			SPAN										
		14'-6"	16'-5"	17'-0"	19'-0"	24'-0"	26'-0"						
	3 5/8"	25 GA	20 GA	18 GA									
STUD	4"	25 GA	25 GA	20 GA	18 GA								
	6"	25 GA	25 GA	25 GA	25 GA	20 GA	18 GA						

GENERAL STUD GAUGE NOTES:

- 1. PROVIDE 20 GAUGE STUDS AT WALL MOUNTED CABINET LOCATIONS AND AT WALLS SCHEDULED TO RECEIVE CERAMIC TILE.
- 2. PROVIDE 16 GAUGE STUDS AT DOOR JAMBS, AND WHERE WALLS SUPPORT HEAVY EQUIPMENT.

WALL KEY



WALL TYPE "A" TYPICAL PARTITION: 35/8" METAL STUDS AT 16" O.C. WITH 1 LAYER OF $\frac{5}{8}$ " GYPSUM BOARD ON EACH FACE. EXTEND METAL STUDS AND GYPSUM BOARD TO 4" ABOVE CEILING AND PROVIDE DIAGONAL BRACING @ 32"

(Interior Walls)

WALL TYPE "A" TYPICAL PARTITION: 6" METAL STUDS AT 16" O.C. WITH 1 LAYER OF %" GYPSUM BOARD ON EACH FACE. EXTEND METAL STUDS AND GYPSUM BOARD TO 4" ABOVE CEILING AND PROVIDE DIAGONAL BRACING @ 32" O.C.

project no. 1804

date 03.10.20

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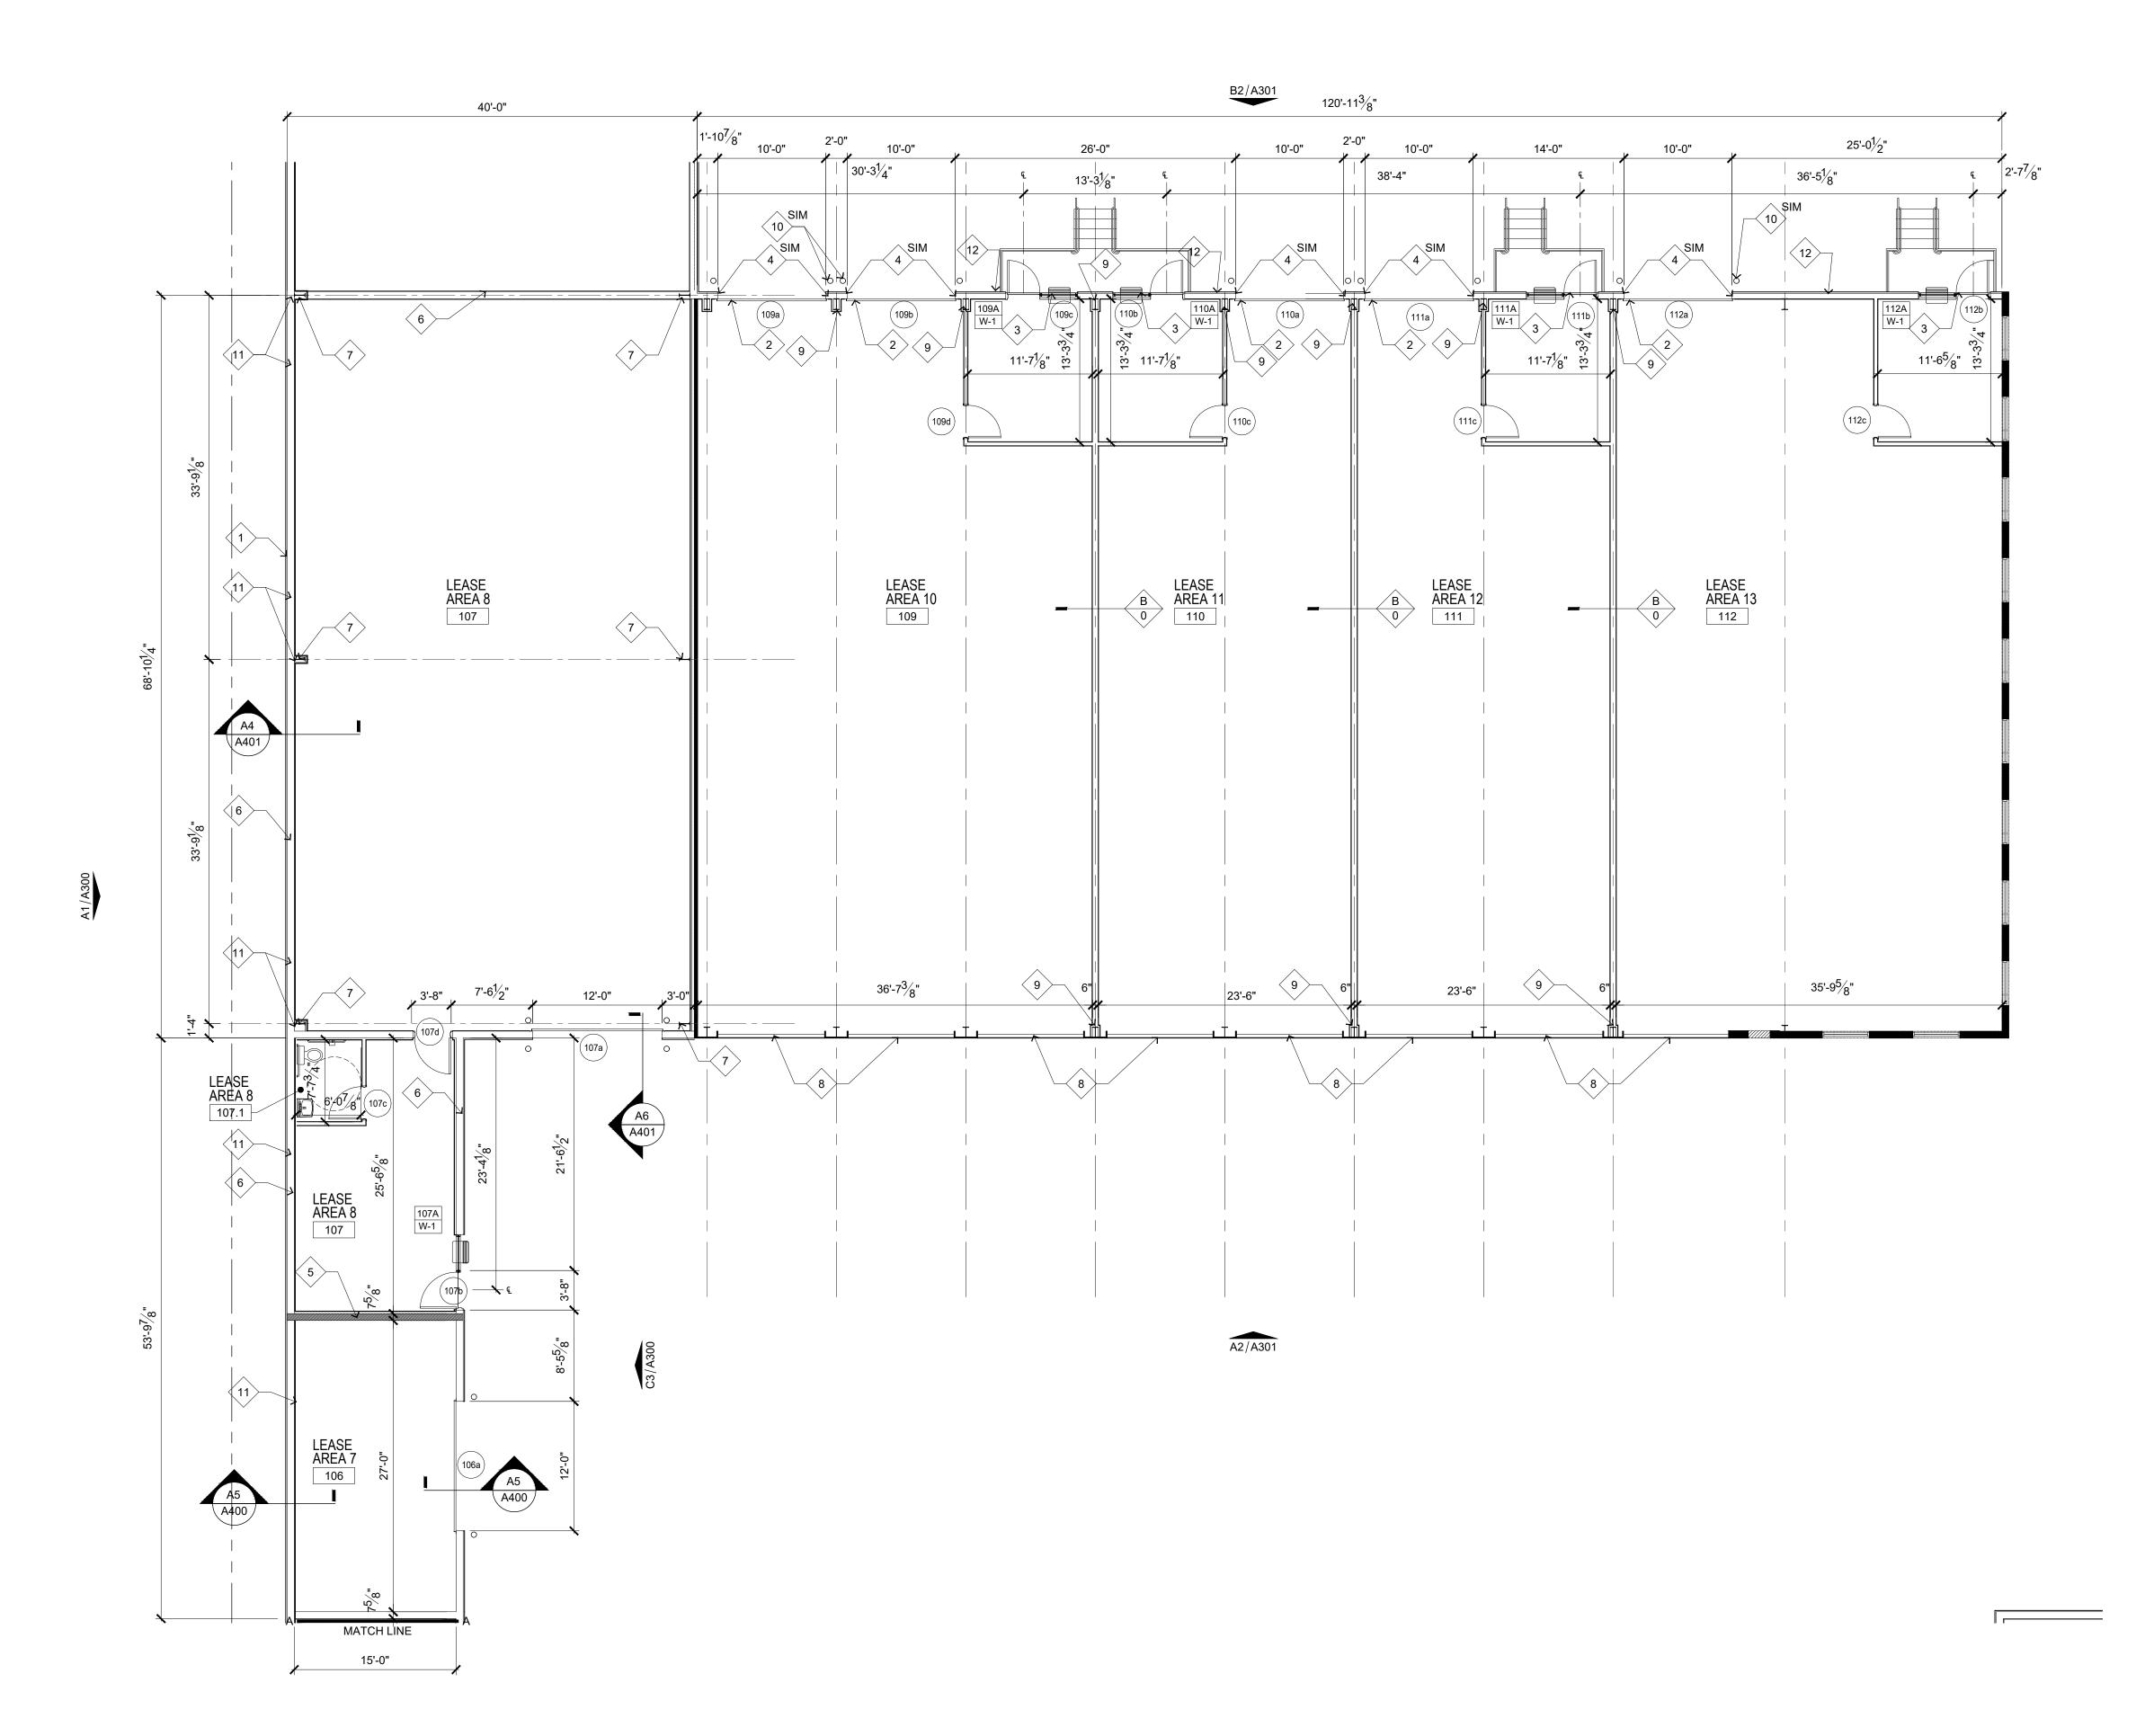
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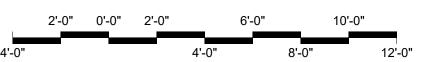
FLOOR PL

drawn by

chk'd by

Jerry W. Herndon,





FLOOR PLAN 1/8" = 1'-0" :SCALE

GENERAL NOTES FLOOR PLAN Floor Plans

ALL DIMENSIONS ARE FROM/TO FACE OF METAL STUDS/MASONRY TO FACE OF METAL STUDS/MASONRY U N O.

DO NOT SCALE DRAWINGS IF DIMENSIONS ARE IN QUESTION, THE CONTRACTOR SHALL BE RESPONSIBLE FOR OBTAINING CLARIFICATION FROM THE ARCHITECT BEFORE CONTINUING WITH CONSTRUCTION. THE CONTRACTOR SHALL VERIFY ALL DIMENSIONS AND CONDITIONS AT THE SITE AND REPORT ANY DISCREPANCY TO #HE ARCHITECT/OWNERS REPRESENTATIVE BEFORE

PROCEED WITH THE WORK. ALL SECTIONS, DETAILS, MATERIALS, METHODS, ETC SHOWN AND/OR NOTED ON ANY PLAN OR SECTION SHALL APPLY TO ALL OTHER SIMILAR CONDITIONS AND LOCATIONS UNLESS NOTED OTHERWISE.

ALL EXTERIOR WALL METAL STUDS SHALL BE 8" - 16 GAUGE METAL STUDS @ 16"

ALL INTERIOR METAL STUDS SHALL BE 3 5/8" @ 24" O. C. U. N. O. SEE GAUGE GUIDE BELOW & WALL TYPE'S LEGEND THIS SHEET. ALL GYPSUM WALL BOARD SHALL BE 5/8" PROVIDE FIRE CODE WHERE NOTED OR

INDICATED BY WALL TYPES. PROVIDE GYPSUM BOARD CONTROL JOINTS IN INTERIOR WALL, COORDINATE LOCATION OF INTERIOR CONTROL JOINTS WITH JOINTS IN EXTERIOR WALL AND AS RECOMMENDED BY USG CONSTRUCTION HANDBOOK AND COMMON

THE CONTRACTOR SHALL PROVIDE WOOD BLOCKING FOR ALL WALL MOUNTED

ACCESSORIES. GYPSUM WALL BOARD ON REST ROOM WET WALLS SHALL BE WATER RESISTANT GYPSUM WALL BOARD.

CONCEAL ALL PIPING IN WALLS. WHERE PIPING WILL NOT FIT IN WALL CAVITY FUR OUT WALL MINIMUM TO CONCEAL PIPING.


REFER TO DOOR SCHEDULE, DETAILS AND SPECIFICATIONS FOR DOOR, DOOR FRAME AND DOOR HARDWARE REQUIREMENTS. DOOR OPENINGS NOT LOCATED BY DIMENSION SHALL BE CENTERED IN WALL AS


SHOWN OR LOCATED 4" FROM NEAREST WALL FINISH TO FINISH OF JAMB OPENING UNLESS NOTED OTHERWISE. ALL WOOD IN CONTACT WITH MASONRY OR CONCRETE SHALL BE PRESSURE

TREATED (PT) WITH AN APPROVED WOOD PRESERVATIVE. REFER GENERAL NOTES ON SHEET CVR FOR ADDITIONAL NOTES. EXPOSED BATT INSULATION AND FACING IN ATTIC AND WALL CAVITY SHALL HAVE A FLAME SPREAD INDEX OF 25 OR LESS AND A SMOKE DEVELOPMENT RATING

OF 450 OR LESS. ALL DISSIMILAR METALLIC MATERIALS SHALL BE EFFECTIVELY ISOLATED FROM EACH OTHER TO PREVENT GALVANIC ACTION.

REFER TO FINISH SCHEDULE FOR TYPE OF PAINT FINISHES, METAL FINISHES CEMENT FINISHES, WEATHER AND SOUND SEALANTS.

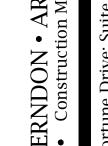

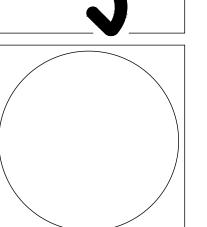

JOHNSON

SHEET NOTES

1. MBM METAL BUILDING PANELS.

2. 120" x 120" SECTIONAL METAL OVERHEAD DOOR (INSULATED). 3. 36" x 84" STOREFRONT DOOR.

4. PROVIDE 8" W x $\frac{1}{4}$ " THICK METAL BENT PLATE W/ 2" MIN. LEG LENGTH ON OUTSIDE FACE OF DOOR AND 4" MIN. LEG LENGTH ON DOOR ANGLE SIDE.

5. 8" CONCRETE MASONRY UNIT WALL W/ 1 5/8" METAL FURRING & 2 LAYERS OF 5/8" TYPE 'X' RATED GYPSUM BOARD. (2 HOUR

6. 8" MBM GIRT WALL. 7. MBM MAIN FRAME.

8. REMOVE EXISTING OVERHEAD DOOR & CLOSE OPENING WITH 6" METAL STUDS W/ $\frac{5}{8}$ ' GYPSUM BOARD AND 1 $\frac{1}{2}$ " METAL SIDING

9. WRAP EXISTING METAL BUILDING MAIN FRAME W/ METAL STUDS & GYPSUM BOARD, EXTEND 4" ABOVE FINISH CLG.

10. 6" Ø METAL PIPE BOLLARD FILL WITH CONCRETE REFER

DETAIL A6/A412 PAINT SAFETY YELLOW 11. EXTERIOR WALLS ADJACENT TO THE PROPERTY LINES WITHIN 5'-0" ARE TO RECEIVE 2 LAYERS OF \(^5/8\)" FRT TYPE 'X' GYPSUM BOARD ON 8" METAL STUDS & 5 1/2" BATT. INSULATION; MAIN FRAMES TO WRAPPED W/ 1 5/8" METAL STUDS AND 2 LAYERS OF

5/8" FRT TYPE 'X' GYPSUM BOARD. EXTEND TO ROOF DECK.

12. BRICK VENEER ON ½" APA PLYWOOD ON 8" METAL STUDS, BRICK TO BE PROVIDED BY OWNER.

METAL STUD GAUGE GUIDE

(GAUGE GUIDE IS FOR INTERIOR PARTITIONS ONLY)


		SPAN										
		14'-6"	16'-5"	17'-0"	19'-0"	24'-0"	26'-0"					
	3 5/8"	25 GA	20 GA	18 GA								
STUD	4"	25 GA	25 GA	20 GA	18 GA							
	6"	25 GA	25 GA	25 GA	25 GA	20 GA	18 GA					

GENERAL STUD GAUGE NOTES:

1. PROVIDE 20 GAUGE STUDS AT WALL MOUNTED CABINET LOCATIONS AND AT WALLS SCHEDULED TO RECEIVE CERAMIC TILE.

2. PROVIDE 16 GAUGE STUDS AT DOOR JAMBS, AND WHERE WALLS SUPPORT HEAVY EQUIPMENT.

(Interior Walls) METAL STUD

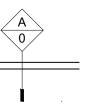

WALL TYPE "A" TYPICAL PARTITION: $3^5\!\!/\!\!8$ " METAL STUDS AT 16" O.C. WITH 1 LAYER OF $^5\!\!/\!\!8$ " GYPSUM BOARD ON EACH FACE. EXTEND METAL STUDS AND GYPSUM BOARD TO 4" ABOVE CEILING AND PROVIDE DIAGONAL BRACING @ 32"




WALL TYPE "A" TYPICAL PARTITION: 6" METAL STUDS AT 16" O.C. WITH 1 LAYER OF $\frac{5}{8}$ " GYPSUM BOARD ON EACH FACE. EXTEND METAL STUDS AND GYPSUM BOARD TO 4" ABOVE CEILING AND PROVIDE DIAGONAL BRACING @ 32" O.C.


Jerry W. Herndon, Architect©2017

03.10.20 chk'd by drawn by JP rev. by

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FLOOR PLAN

1/8" = 1'-0" :SCALE

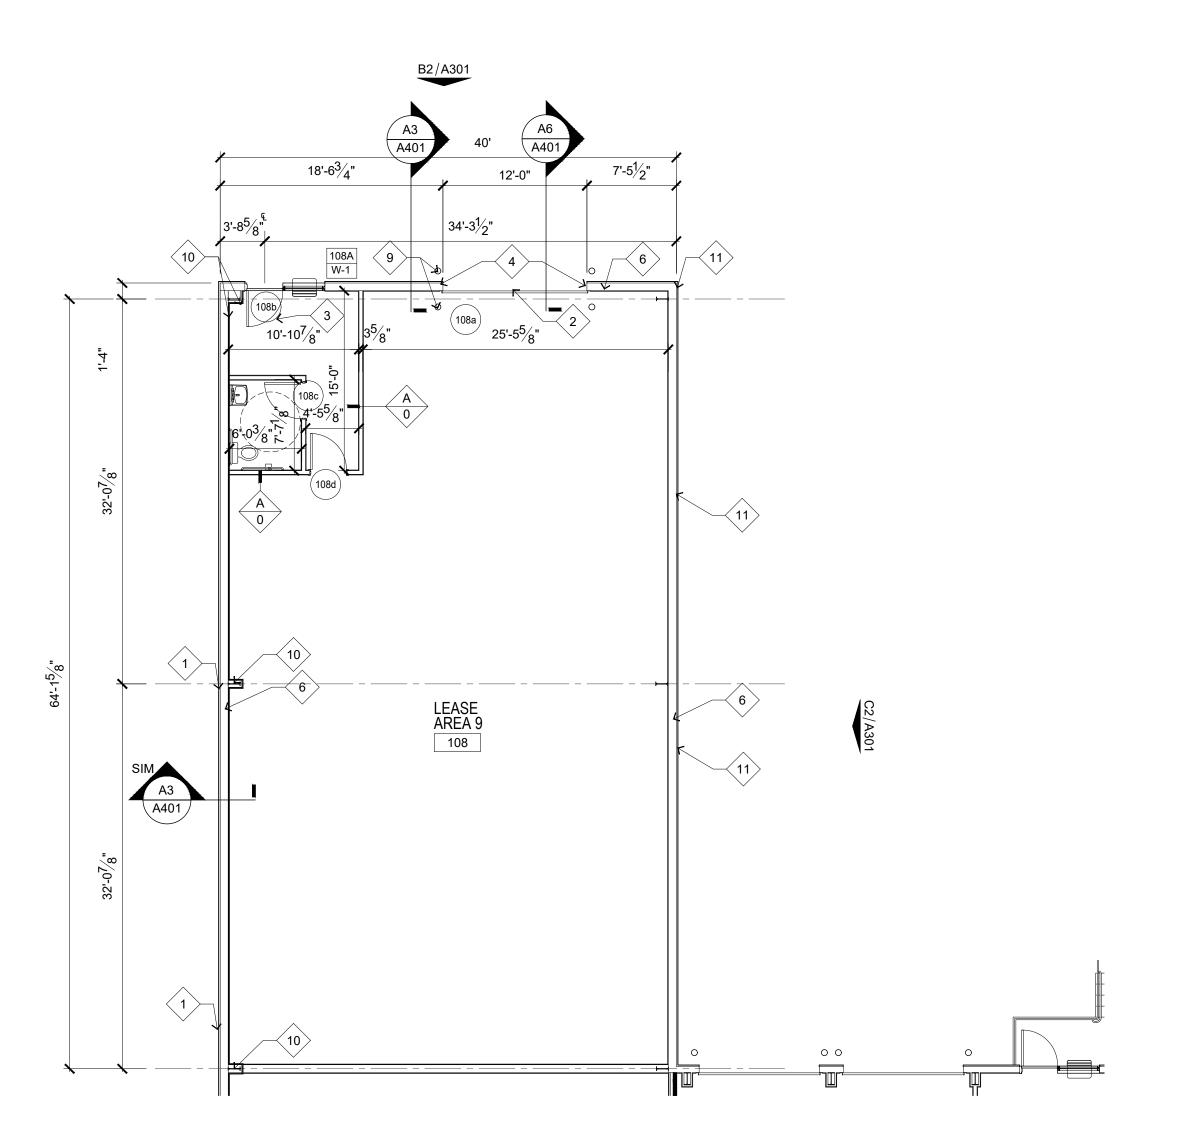GENERAL NOTES FLOOR PLAN

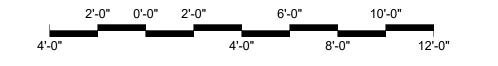ALL DIMENSIONS ARE FROM/TO FACE OF METAL STUDS/MASONRY TO FACE OF METAL STUDS/MASONRY U N O.

DO NOT SCALE DRAWINGS IF DIMENSIONS ARE IN QUESTION, THE CONTRACTOR SHALL BE RESPONSIBLE FOR OBTAINING CLARIFICATION FROM THE ARCHITECT BEFORE CONTINUING WITH CONSTRUCTION. THE CONTRACTOR SHALL VERIFY ALL DIMENSIONS AND CONDITIONS AT THE SITE AND REPORT ANY DISCREPANCY TO THE ARCHITECT/OWNERS REPRESENTATIVE BEFORE

PROCEED WITH THE WORK. ALL SECTIONS, DETAILS, MATERIALS, METHODS, ETC SHOWN AND/OR NOTED ON ANY PLAN OR SECTION SHALL APPLY TO ALL OTHER SIMILAR CONDITIONS AND

LOCATIONS UNLESS NOTED OTHERWISE. ALL EXTERIOR WALL METAL STUDS SHALL BE 8" - 16 GAUGE METAL STUDS @ 16"

ALL INTERIOR METAL STUDS SHALL BE 3 5/8" @ 24" O. C. U. N. O. SEE GAUGE GUIDE BELOW & WALL TYPE'S LEGEND THIS SHEET.

ALL GYPSUM WALL BOARD SHALL BE 5/8" PROVIDE FIRE CODE WHERE NOTED OR INDICATED BY WALL TYPES. PROVIDE GYPSUM BOARD CONTROL JOINTS IN INTERIOR WALL, COORDINATE LOCATION OF INTERIOR CONTROL JOINTS WITH JOINTS IN EXTERIOR WALL

AND AS RECOMMENDED BY USG CONSTRUCTION HANDBOOK AND COMMON THE CONTRACTOR SHALL PROVIDE WOOD BLOCKING FOR ALL WALL MOUNTED

GYPSUM WALL BOARD ON REST ROOM WET WALLS SHALL BE WATER RESISTANT GYPSUM WALL BOARD.

CONCEAL ALL PIPING IN WALLS. WHERE PIPING WILL NOT FIT IN WALL CAVITY FUR OUT WALL MINIMUM TO CONCEAL PIPING. REFER TO DOOR SCHEDULE, DETAILS AND SPECIFICATIONS FOR DOOR, DOOR

FRAME AND DOOR HARDWARE REQUIREMENTS. DOOR OPENINGS NOT LOCATED BY DIMENSION SHALL BE CENTERED IN WALL AS SHOWN OR LOCATED 4" FROM NEAREST WALL FINISH TO FINISH OF JAMB

OPENING UNLESS NOTED OTHERWISE. ALL WOOD IN CONTACT WITH MASONRY OR CONCRETE SHALL BE PRESSURE TREATED (PT) WITH AN APPROVED WOOD PRESERVATIVE.

REFER GENERAL NOTES ON SHEET CVR FOR ADDITIONAL NOTES. EXPOSED BATT INSULATION AND FACING IN ATTIC AND WALL CAVITY SHALL HAVE A FLAME SPREAD INDEX OF 25 OR LESS AND A SMOKE DEVELOPMENT RATING OF 450 OR LESS.

ALL DISSIMILAR METALLIC MATERIALS SHALL BE EFFECTIVELY ISOLATED FROM EACH OTHER TO PREVENT GALVANIC ACTION.

REFER TO FINISH SCHEDULE FOR TYPE OF PAINT FINISHES, METAL FINISHES CEMENT FINISHES, WEATHER AND SOUND SEALANTS.

SHEET NOTES

MBM METAL BUILDING PANELS.

2. 144" x 144" SECTIONAL METAL OVERHEAD DOOR (INSULATED). 3. 36" x 84" STOREFRONT DOOR.

4. PROVIDE 8" W x $\frac{1}{4}$ " THICK METAL BENT PLATE W/ 2" MIN. LEG LENGTH ON OUTSIDE FACE OF DOOR AND 4" MIN. LEG LENGTH ON DOOR ANGLE SIDE.

NOT USED

ACCESSORIES.

8" MBM GIRT WALL.

MBM MAIN FRAME. 8. WRAP METAL BUILDING MAIN FRAME W/ METAL STUDS &

GYPSUM BOARD, EXTEND 4" ABOVE FINISH CLG. 9. 6" Ø METAL PIPE BOLLARD FILL WITH CONCRETE REFER

DETAIL A6/A412 PAINT SAFETY YELLOW 10. EXTERIOR WALLS ADJACENT TO THE PROPERTY LINES WITHIN 5'-0" ARE TO RECEIVE 2 LAYERS OF 5/8" FRT TYPE 'X' GYPSUM BOARD ON 8" METAL STUDS & 5 $\frac{1}{2}$ " BATT. INSULATION; MAIN FRAMES TO WRAPPED W/ 1 5/8" METAL STUDS AND 2 LAYERS OF

5/8" FRT TYPE 'X' GYPSUM BOARD. EXTEND TO ROOF DECK. 11. BRICK VENEER ON ½" APA PLYWOOD ON 8" METAL STUDS,

BRICK TO BE PROVIDED BY OWNER.

METAL STUD GAUGE GUIDE

(GAUGE GUIDE IS FOR INTERIOR PARTITIONS ONLY)

		SPAN									
		14'-6"	16'-5"	17'-0"	19'-0"	24'-0"	26'-0"				
	3 5/8"	25 GA	20 GA	18 GA							
STUD	4"	25 GA	25 GA	20 GA	18 GA						
	6"	25 GA	25 GA	25 GA	25 GA	20 GA	18 GA				


GENERAL STUD GAUGE NOTES:

1. PROVIDE 20 GAUGE STUDS AT WALL MOUNTED CABINET LOCATIONS AND AT WALLS SCHEDULED TO RECEIVE CERAMIC TILE.


2. PROVIDE 16 GAUGE STUDS AT DOOR JAMBS, AND WHERE WALLS SUPPORT HEAVY EQUIPMENT.

WALL KEY

(Interior Walls)

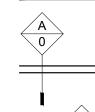

WALL TYPE "A" TYPICAL PARTITION: 35/8" METAL STUDS AT 16" O.C. WITH 1 LAYER OF $\frac{5}{8}$ " GYPSUM BOARD ON EACH FACE. EXTEND METAL STUDS AND GYPSUM BOARD TO 4" ABOVE CEILING AND PROVIDE DIAGONAL BRACING @ 32"

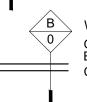

WALL TYPE "A" TYPICAL PARTITION: 6" METAL STUDS AT 16" O.C. WITH 1 LAYER OF $\frac{5}{8}$ " GYPSUM BOARD ON EACH FACE. EXTEND METAL STUDS AND GYPSUM BOARD TO 4" ABOVE CEILING AND PROVIDE DIAGONAL BRACING @ 32" O.C.


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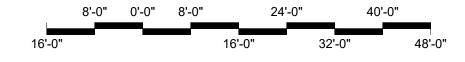
JOHNSON

05.22.19

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by



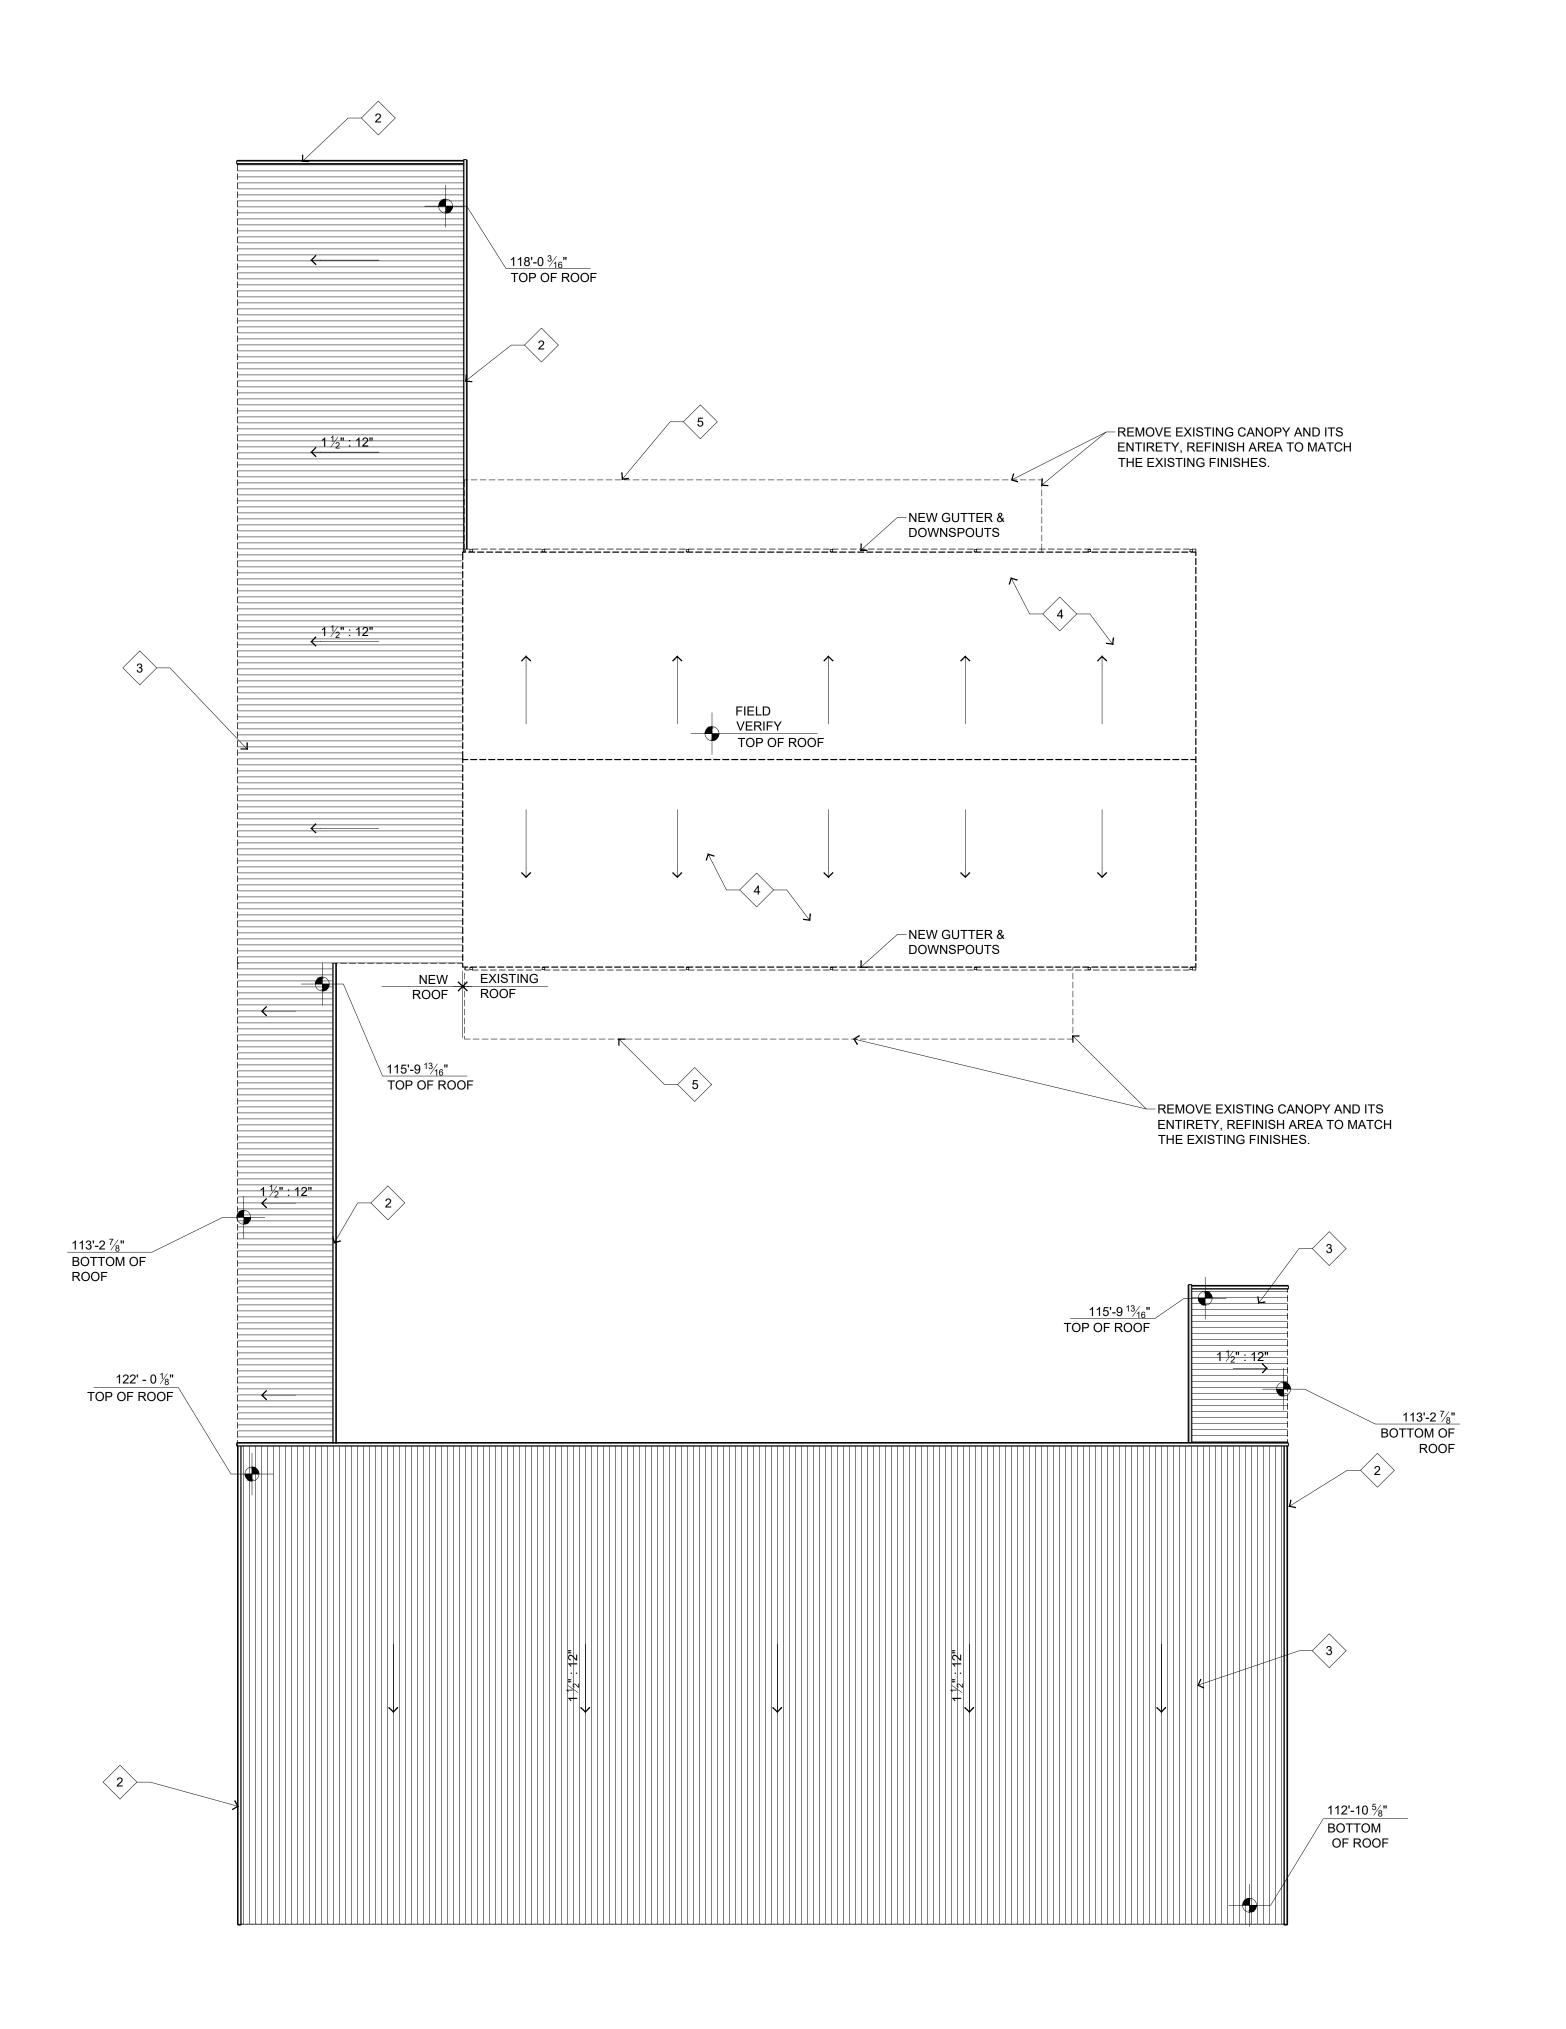

ROOF PLAN | 1/16" = 1'-0" :SCALE

GENERAL NOTES

ALL ROOFING MATERIALS SHALL BE FROM THE ROOFING MANUFACTURER OR BE APPROVED BY THE ROOFING SYSTEM MANUFACTURER FOR USE ON THE ROOFING SYSTEM INSTALLED AND MUST NOT VOID ROOFING MANUFACTURERS WARRANTY.

ROOFING INSTALLATION AND INSTALLATION DETAILS SHALL COMPLY WITH ROOFING MANUFACTURER AND THE LATEST LATEST EDITION OF THE NRCA ROOFING MANUAL.


ALL FLASHING, SCUPPERS, GUTTERS AND DOWNSPOUTS PROFILES AND SIZES SHALL COMPLY WITH THE LATEST EDITION OF THE SMACNA

ARCHITECTURAL SHEET METAL MANUAL. ROOFING CONTRACTOR SHALL PROVIDE MANUFACTURER STANDARD IS YEAR WARRANTY ON ROOFING SYSTEM.

SHEET NOTES



- MBM STANDARD GUTTER AND DOWN SPOUT.
 MBM HIGH EVE RAKE TRIM.
 MBM STANDING SEAM ROOF WITH 1½": 12" STANDOFF.
 EXISTING METAL ROOF
 EXISTING MBM METAL CANOPY

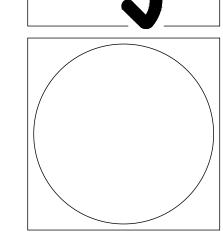

JOHNSON REALTY


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drawn by JP

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GENERAL NOTES CEILING PLAN

ALL EXPOSED INTERIOR GYPSUM BOARD CEILINGS, SOFFITS AND BULKHEADS SHALL RECEIVE A LEVEL 5 FINISH. REFER TO U S G CONSTRUCTION HANDBOOK FOR REQUIREMENTS.

COORDINATE WITH MECHANICAL AND ELECTRICAL DRAWINGS FOR SUPPLY AIR DIFFUSERS, RETURN AIR DIFFUSERS AND ELECTRICAL LIGHT AND OTHER CEILING MOUNTED FIXTURES.

REFER TO MECHANICAL DRAWINGS PROVIDE ACCESS PANELS AS REQUIRED IN GYPSUM BOARD CEILINGS WHERE MECHANICAL EQUIPMENT IS LOCATED ABOVE

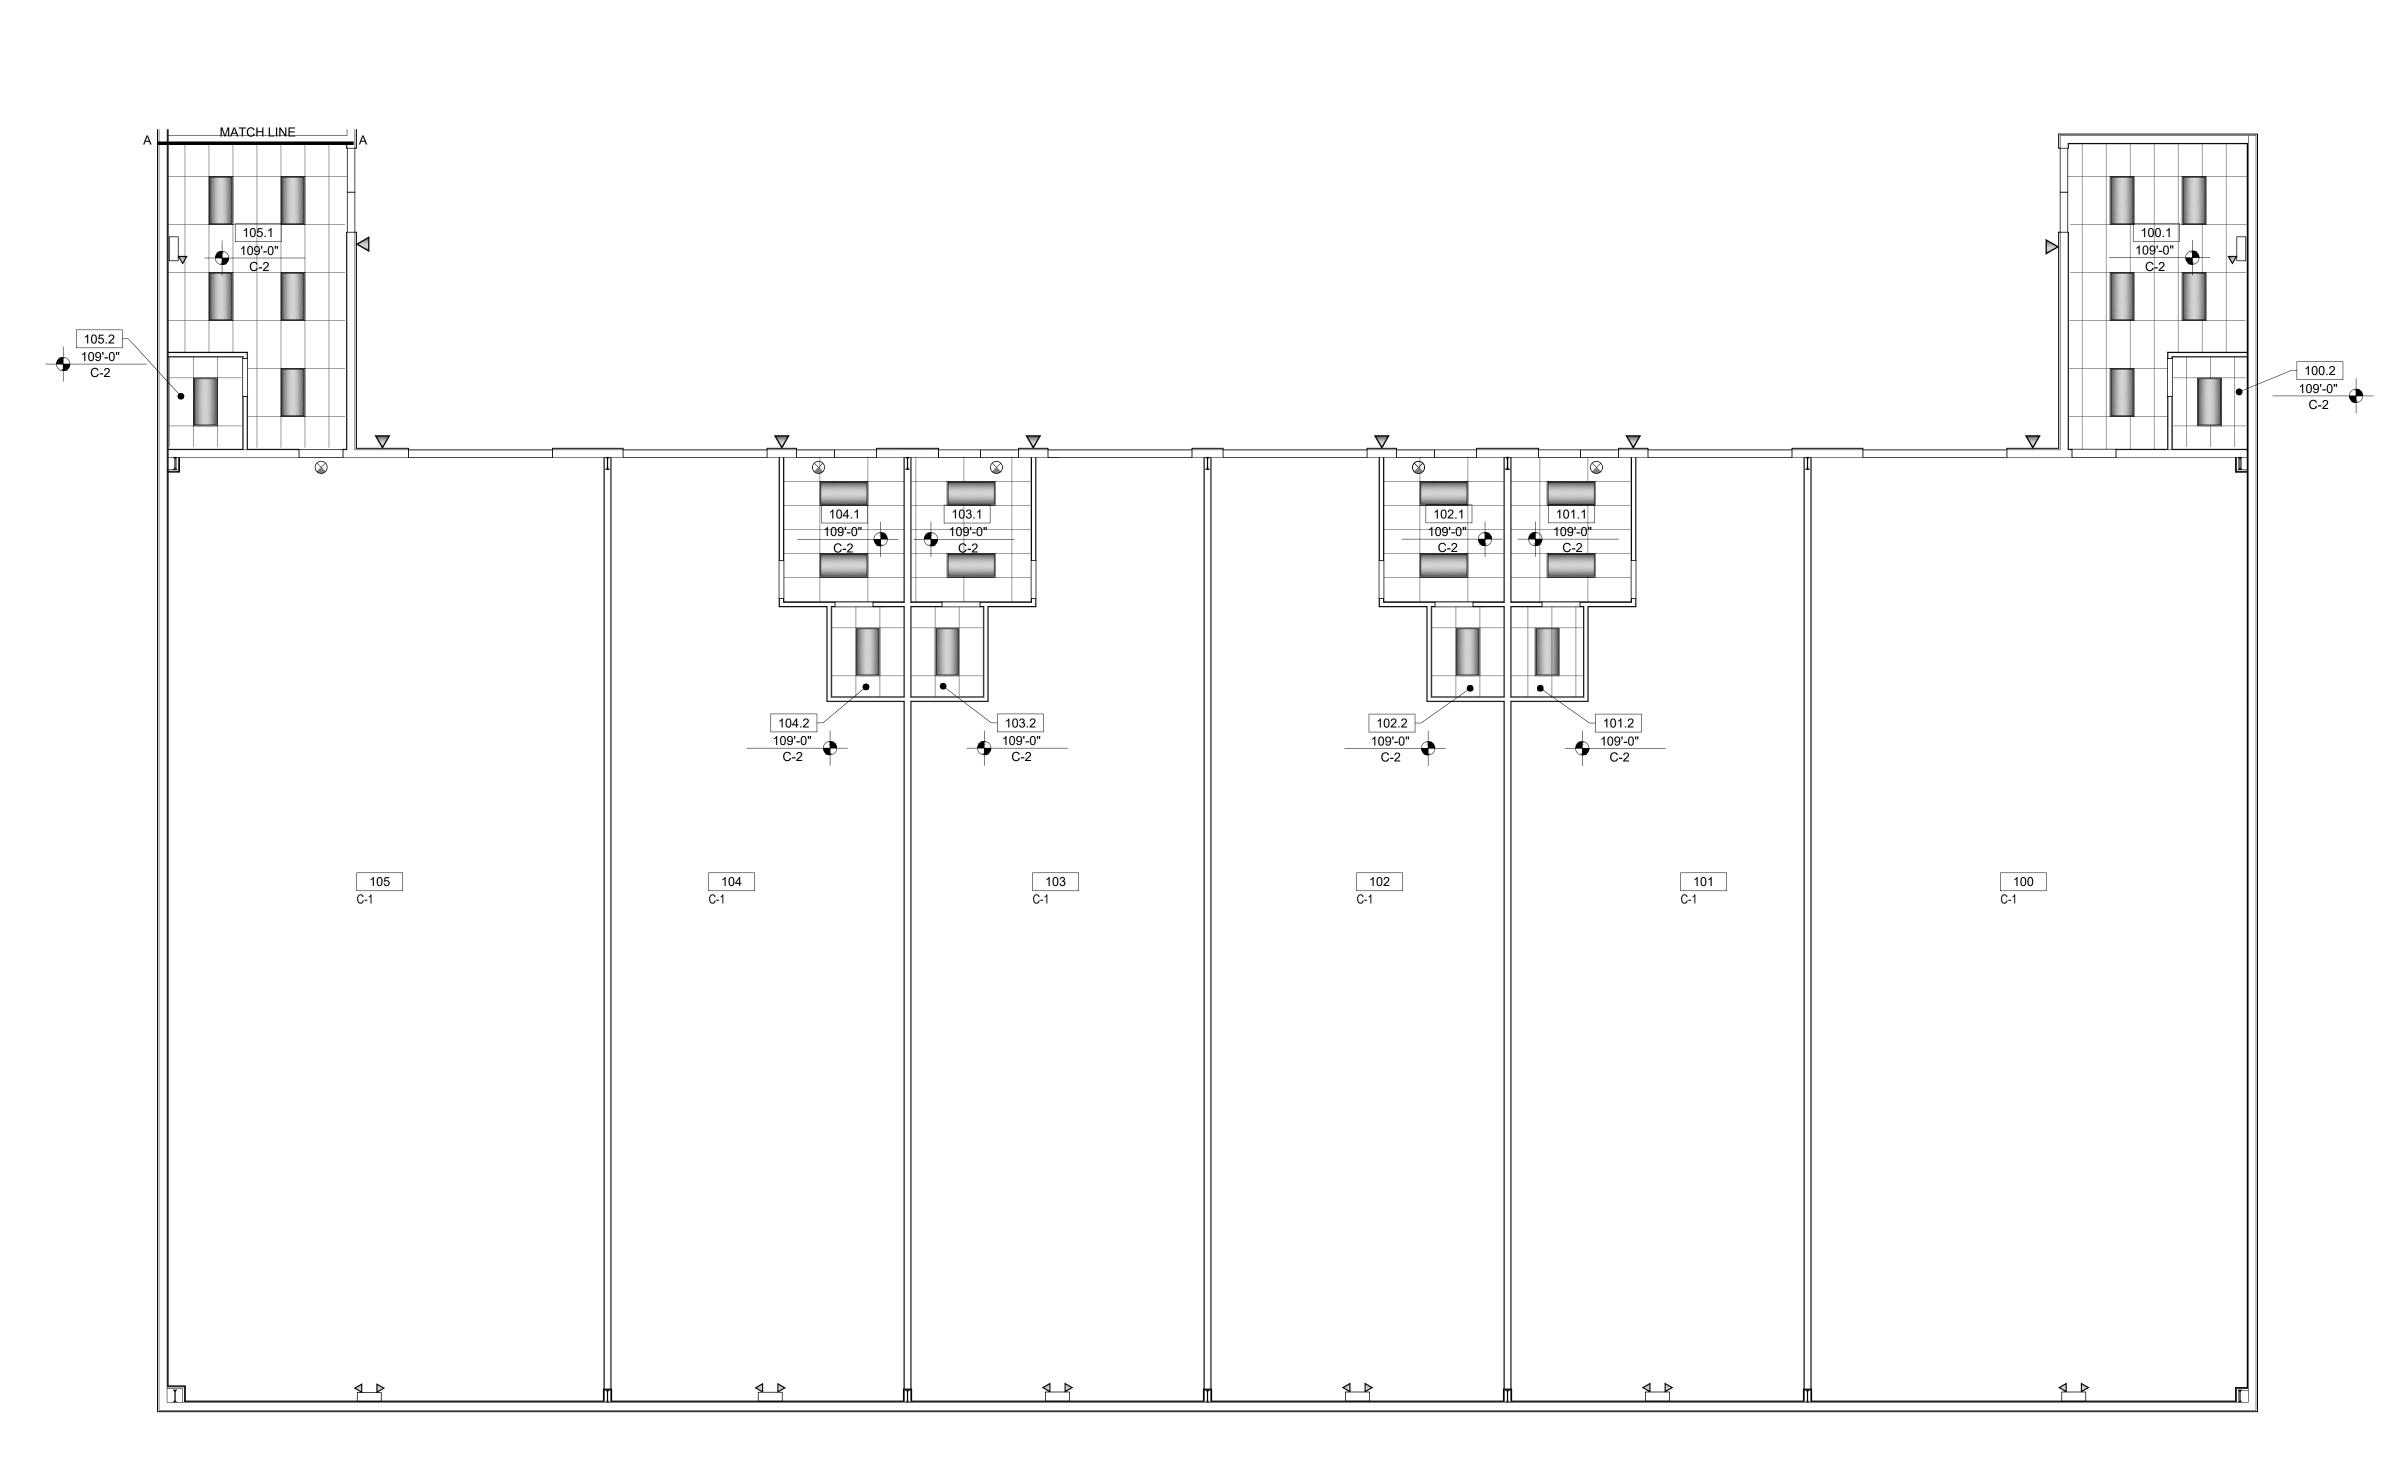CEILINGS. INDEPENDENT FRAMING AND ATTACHMENTS TO THE STRUCTURE SHALL BE ADEQUATE TO SUPPORT THE CEILING SYSTEM (INCLUDING LIGHTING, DIFFUSERS ETC.) WHERE DUCTWORK INTERFERES WITH NORMAL SUSPENSION.

ATTACHMENT OF HANGERS OR FRAMING TO DUCTWORK IS PROHIBITED. ALL DUCT PENETRATIONS THROUGH PARTITIONS AND CEILING SHALL BE PROVIDED WITH NECESSARY FRAMES AND BRACING AROUND THE OPENING AND SHALL BE PROVIDED WITH AUTOMATIC FIRE DAMPERS AS REQUIRED BY THE BUILDING DEPARTMENT FOR FIRE-RATED PENETRATIONS.

ALL EXITS LIGHTING AND SIGNS TO HAVE MINIMUM 6-INCH HIGH LETTERS IN ACCORDANCE WITH K B C 2013.

EMERGENCY LIGHTING SHALL BE PROVIDED GIVING A MINIMUM VALUE ONE (1) FOOTCANDLE AT FLOOR LEVEL. EXIT SIGNS SHALL BE ILLUMINATED BY TWO SEPARATE SOURCES OF POWER PER LOCAL FIRE DEPARTMENT. (ONE SOURCE ON EMERGENCY POWER, SEE ELECTRICAL DRAWINGS.)

PROVIDE AN AUDIBLE AND VISUAL FIRE ALARM SYSTEM AS REQUIRED BY NFPA, IBC 2012, KBC 2013 AND ADA.

CEILING KEY

C-1 - NO CEILING/FINISH STRUCTURE / FACE OF INSULATION


C-2 - ACOUSTICAL CEILING SYSTEM: 2X4 ACOUSTICAL CEILING TILE ARMSTRONG FINE FISHERED SECOND LOOK WITH BEVELED TEGULAR EDGE (OR EQUAL)

24" X 48" RECESSED FLUORESCENT LIGHT SEE ELECTRICAL DRAWINGS "E" DEMOTES EMERGENCY LIGHT WITH BATTERY BACK-UP

EMERGENCY LIGHTING ONE HEAD AND TWO HEAD W/ BATTERY BACK-UP WALL MOUNT SEE ELECTRICAL LIGHTING PLAN

> EMERGENCY LIGHT ONE HEAD W/ REMOTE BATTERY BACKUP SEE ELECTRICAL LIGHTING PLAN

EMERGENCY EXIT SIGN AND EMERGENCY LIGHTS W/ REMOTE BATTERY BAACK-UP SEE ELECTRICAL LIGHTING

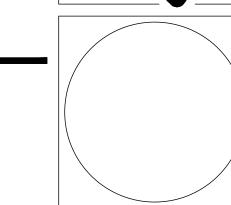

1000 West New Circle Road Lexington, Ky 40511

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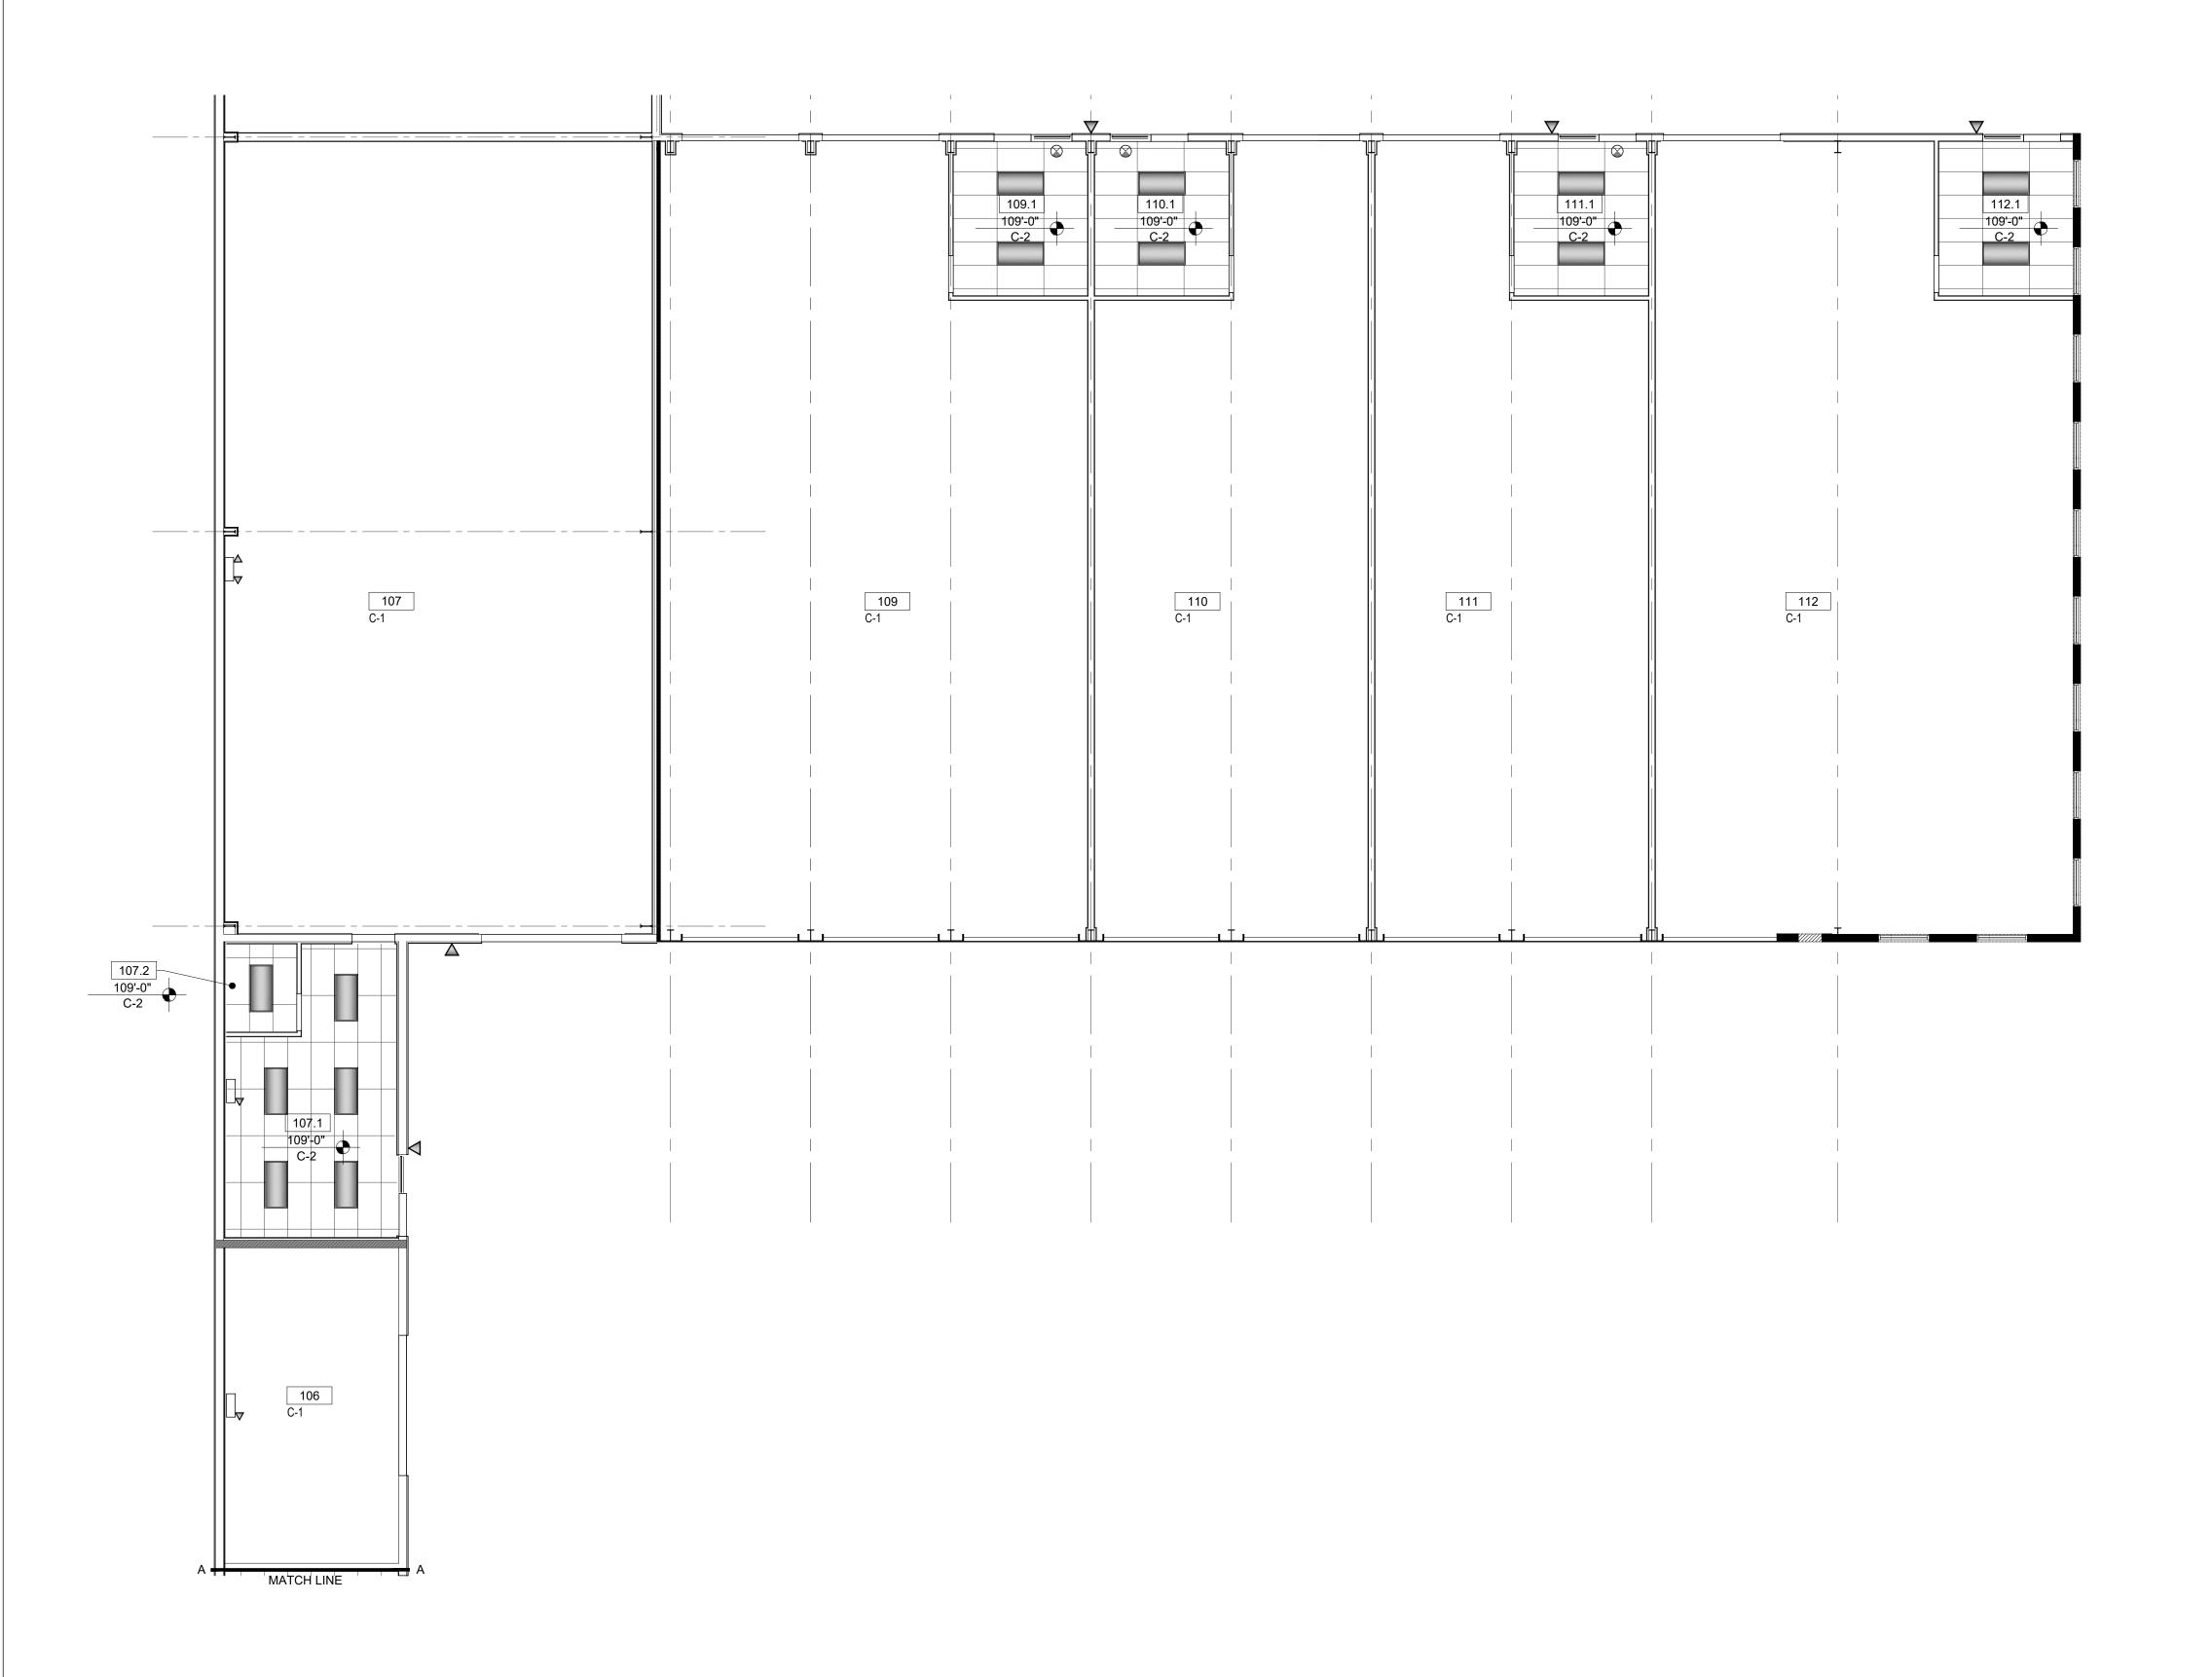
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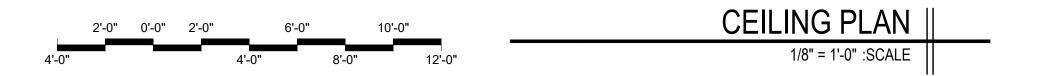
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GENERAL NOTES CEILING PLAN


- ALL EXPOSED INTERIOR GYPSUM BOARD CEILINGS, SOFFITS AND BULKHEADS SHALL RECEIVE A LEVEL 5 FINISH. REFER TO U S G CONSTRUCTION HANDBOOK FOR REQUIREMENTS.
- COORDINATE WITH MECHANICAL AND ELECTRICAL DRAWINGS FOR SUPPLY AIR DIFFUSERS, RETURN AIR DIFFUSERS AND ELECTRICAL LIGHT AND OTHER
- CEILING MOUNTED FIXTURES. REFER TO MECHANICAL DRAWINGS PROVIDE ACCESS PANELS AS REQUIRED IN
- GYPSUM BOARD CEILINGS WHERE MECHANICAL EQUIPMENT IS LOCATED ABOVE
- INDEPENDENT FRAMING AND ATTACHMENTS TO THE STRUCTURE SHALL BE ADEQUATE TO SUPPORT THE CEILING SYSTEM (INCLUDING LIGHTING, DIFFUSERS ETC.) WHERE DUCTWORK INTERFERES WITH NORMAL SUSPENSION.
- ATTACHMENT OF HANGERS OR FRAMING TO DUCTWORK IS PROHIBITED. ALL DUCT PENETRATIONS THROUGH PARTITIONS AND CEILING SHALL BE PROVIDED WITH NECESSARY FRAMES AND BRACING AROUND THE OPENING AND SHALL BE PROVIDED WITH AUTOMATIC FIRE DAMPERS AS REQUIRED BY THE BUILDING
- ALL EXITS LIGHTING AND SIGNS TO HAVE MINIMUM 6-INCH HIGH LETTERS IN ACCORDANCE WITH K B C 2013.

DEPARTMENT FOR FIRE-RATED PENETRATIONS.

- EMERGENCY LIGHTING SHALL BE PROVIDED GIVING A MINIMUM VALUE ONE (1) FOOTCANDLE AT FLOOR LEVEL. EXIT SIGNS SHALL BE ILLUMINATED BY TWO SEPARATE SOURCES OF POWER PER LOCAL FIRE DEPARTMENT. (ONE SOURCE
- ON EMERGENCY POWER, SEE ELECTRICAL DRAWINGS.) PROVIDE AN AUDIBLE AND VISUAL FIRE ALARM SYSTEM AS REQUIRED BY NFPA, IBC 2012, KBC 2013 AND ADA.

CEILING KEY

C-1 - NO CEILING/FINISH STRUCTURE / FACE OF

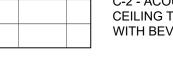

C-2 - ACOUSTICAL CEILING SYSTEM: 2X4 ACOUSTICAL CEILING TILE ARMSTRONG FINE FISHERED SECOND LOOK WITH BEVELED TEGULAR EDGE (OR EQUAL)




24" X 48" RECESSED FLUORESCENT LIGHT SEE ELECTRICAL DRAWINGS "E" DEMOTES EMERGENCY LIGHT WITH BATTERY BACK-UP




EMERGENCY LIGHTING ONE HEAD AND TWO HEAD W/ BATTERY BACK-UP WALL MOUNT SEE ELECTRICAL LIGHTING PLAN



EMERGENCY LIGHT ONE HEAD W/ REMOTE BATTERY BACKUP SEE ELECTRICAL LIGHTING PLAN

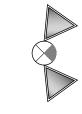

EMERGENCY EXIT SIGN AND EMERGENCY LIGHTS W/ REMOTE BATTERY BAACK-UP SEE ELECTRICAL LIGHTING

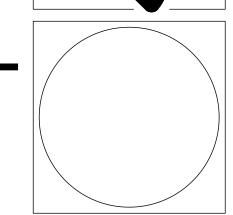


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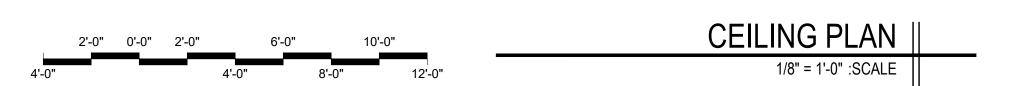
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GENERAL NOTES CEILING PLAN

- ALL EXPOSED INTERIOR GYPSUM BOARD CEILINGS, SOFFITS AND BULKHEADS SHALL RECEIVE A LEVEL 5 FINISH. REFER TO U S G CONSTRUCTION HANDBOOK FOR REQUIREMENTS.
- COORDINATE WITH MECHANICAL AND ELECTRICAL DRAWINGS FOR SUPPLY AIR DIFFUSERS, RETURN AIR DIFFUSERS AND ELECTRICAL LIGHT AND OTHER
- DIFFUSERS, RETURN AIR DIFFUSERS AND ELECTRICAL LIGHT AND OTHER CEILING MOUNTED FIXTURES.

 REFER TO MECHANICAL DRAWINGS PROVIDE ACCESS PANELS AS REQUIRED IN


GYPSUM BOARD CEILINGS WHERE MECHANICAL EQUIPMENT IS LOCATED ABOVE

- CEILINGS.
 INDEPENDENT FRAMING AND ATTACHMENTS TO THE STRUCTURE SHALL BE
 ADEQUATE TO SUPPORT THE CEILING SYSTEM (INCLUDING LIGHTING,
- DIFFUSERS ETC.) WHERE DUCTWORK INTERFERES WITH NORMAL SUSPENSION.
 ATTACHMENT OF HANGERS OR FRAMING TO DUCTWORK IS PROHIBITED.
 ALL DUCT PENETRATIONS THROUGH PARTITIONS AND CEILING SHALL BE PROVIDED
- WITH NECESSARY FRAMES AND BRACING AROUND THE OPENING AND SHALL BE PROVIDED WITH AUTOMATIC FIRE DAMPERS AS REQUIRED BY THE BUILDING DEPARTMENT FOR FIRE-RATED PENETRATIONS.
- ALL EXITS LIGHTING AND SIGNS TO HAVE MINIMUM 6-INCH HIGH LETTERS IN ACCORDANCE WITH K B C 2013.
- EMERGENCY LIGHTING SHALL BE PROVIDED GIVING A MINIMUM VALUE ONE (1)
 FOOTCANDLE AT FLOOR LEVEL. EXIT SIGNS SHALL BE ILLUMINATED BY TWO
 SEPARATE SOURCES OF POWER PER LOCAL FIRE DEPARTMENT. (ONE SOURCE
 ON EMERGENCY POWER, SEE ELECTRICAL DRAWINGS.)
- PROVIDE AN AUDIBLE AND VISUAL FIRE ALARM SYSTEM AS REQUIRED BY NFPA, IBC 2012, KBC 2013 AND ADA.

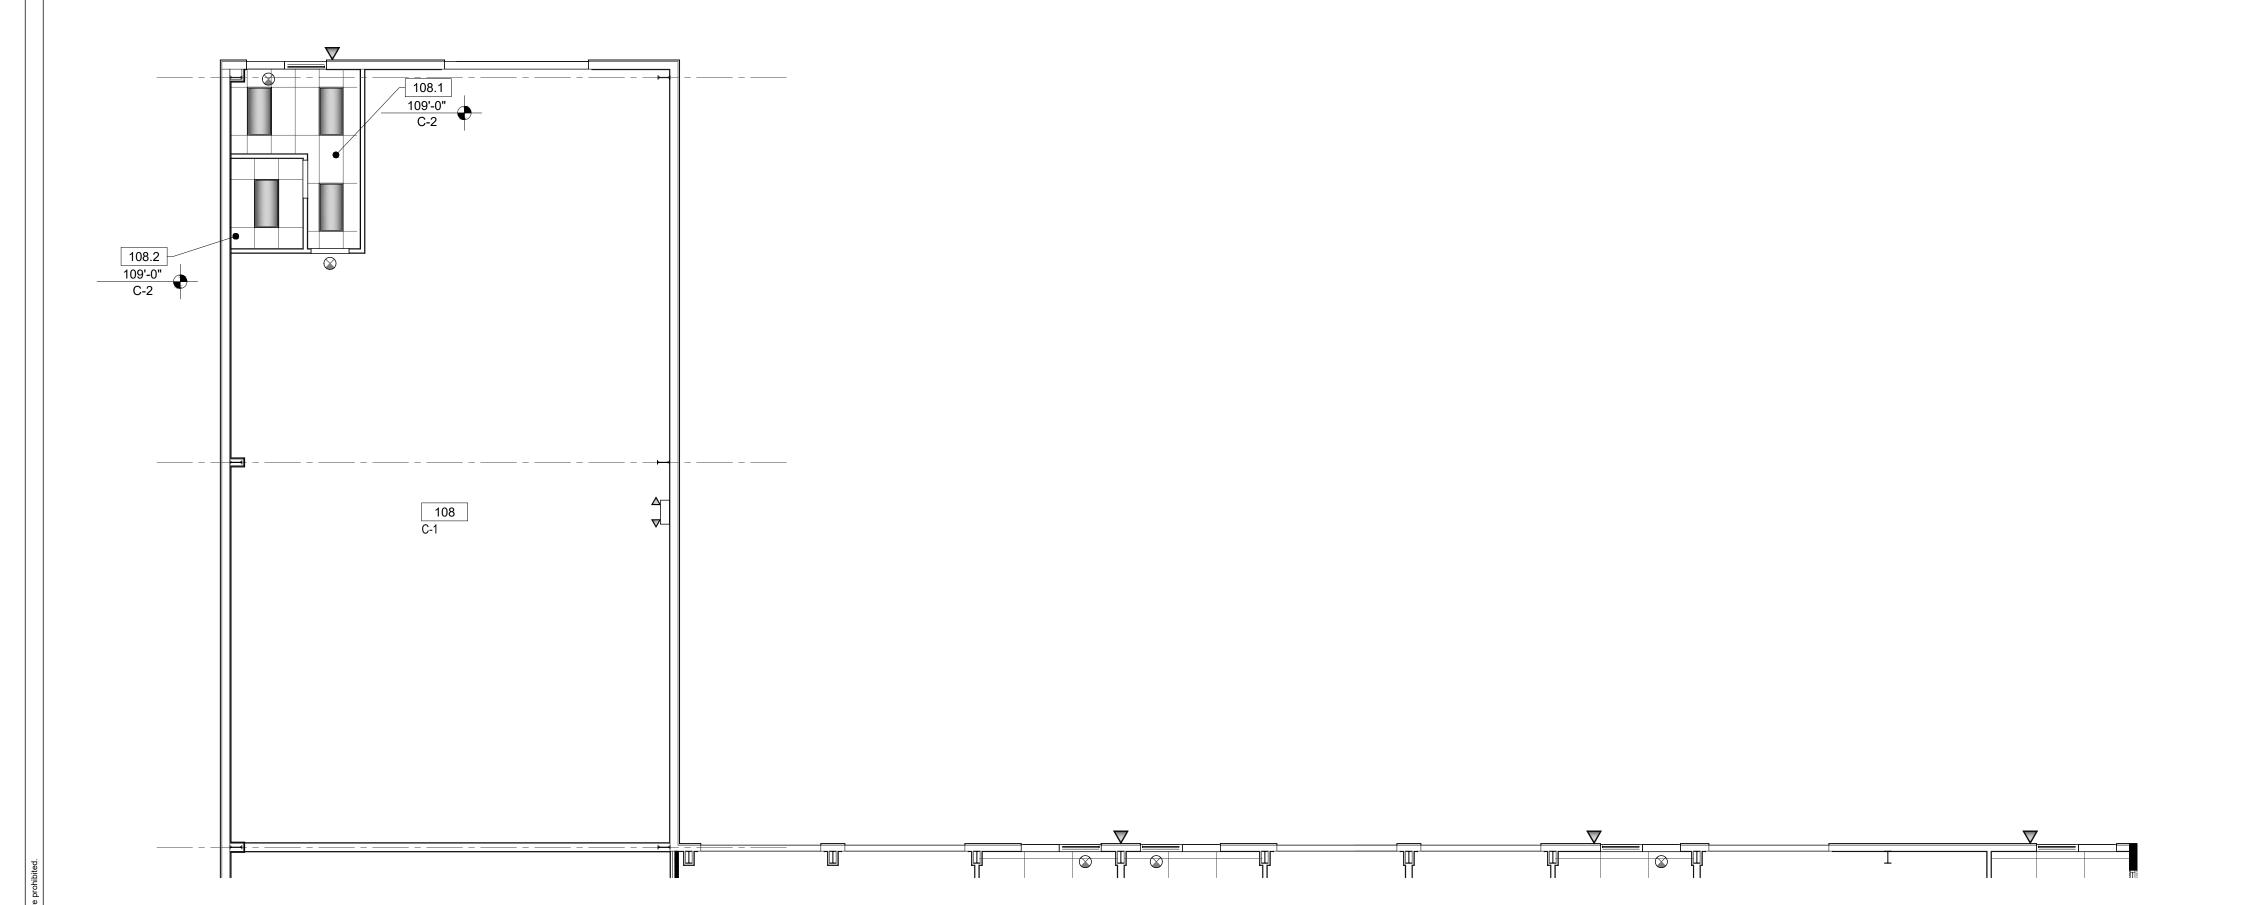CEILING KEY



C-1 - NO CEILING/FINISH STRUCTURE / FACE OF INSULATION

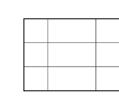

C-2 - ACOUSTICAL CEILING SYSTEM: 2X4 ACOUSTICAL CEILING TILE ARMSTRONG FINE FISHERED SECOND LOOK WITH BEVELED TEGULAR EDGE (OR EQUAL)




24" X 48" RECESSED FLUORESCENT LIGHT SEE ELECTRICAL DRAWINGS "E" DEMOTES EMERGENCY LIGHT WITH BATTERY BACK-UP




EMERGENCY LIGHTING ONE HEAD AND TWO HEAD W/ BATTERY BACK-UP WALL MOUNT SEE ELECTRICAL LIGHTING PLAN



EMERGENCY LIGHT ONE HEAD W/ REMOTE BATTERY BACKUP SEE ELECTRICAL LIGHTING PLAN

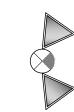

EMERGENCY EXIT SIGN AND EMERGENCY LIGHTS W/
REMOTE BATTERY BAACK-UP SEE ELECTRICAL LIGHTING

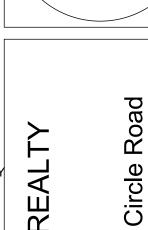

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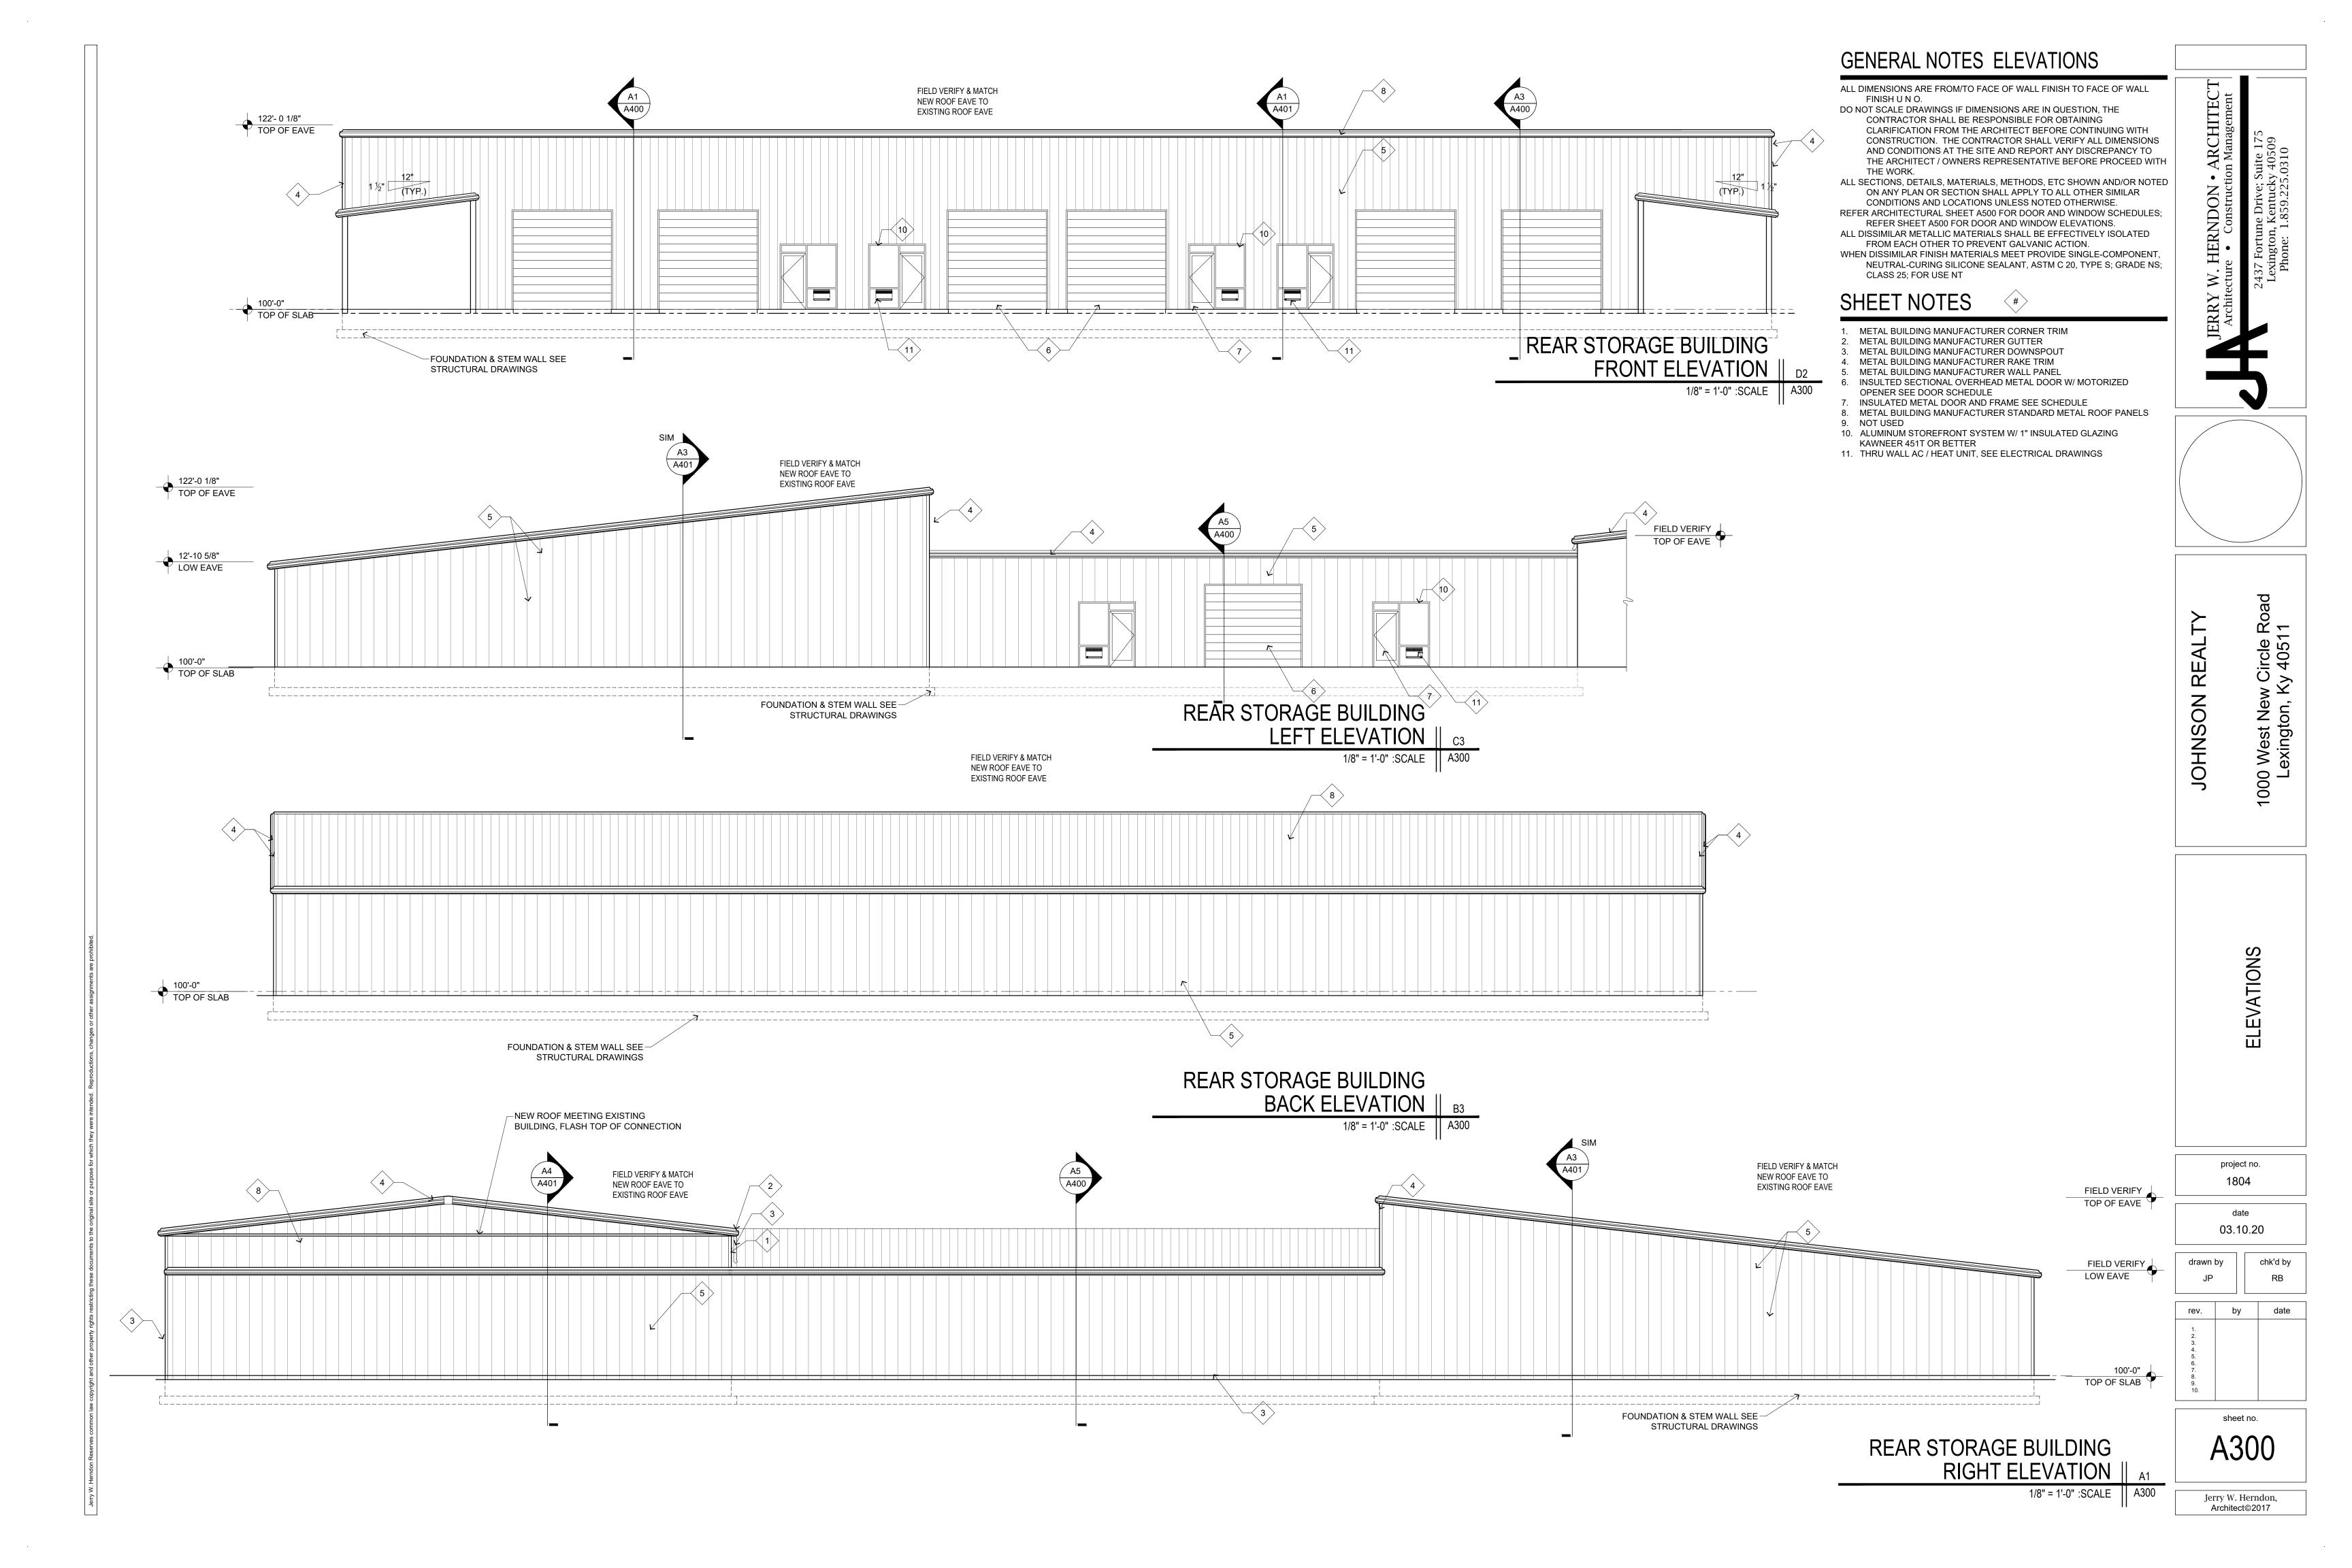
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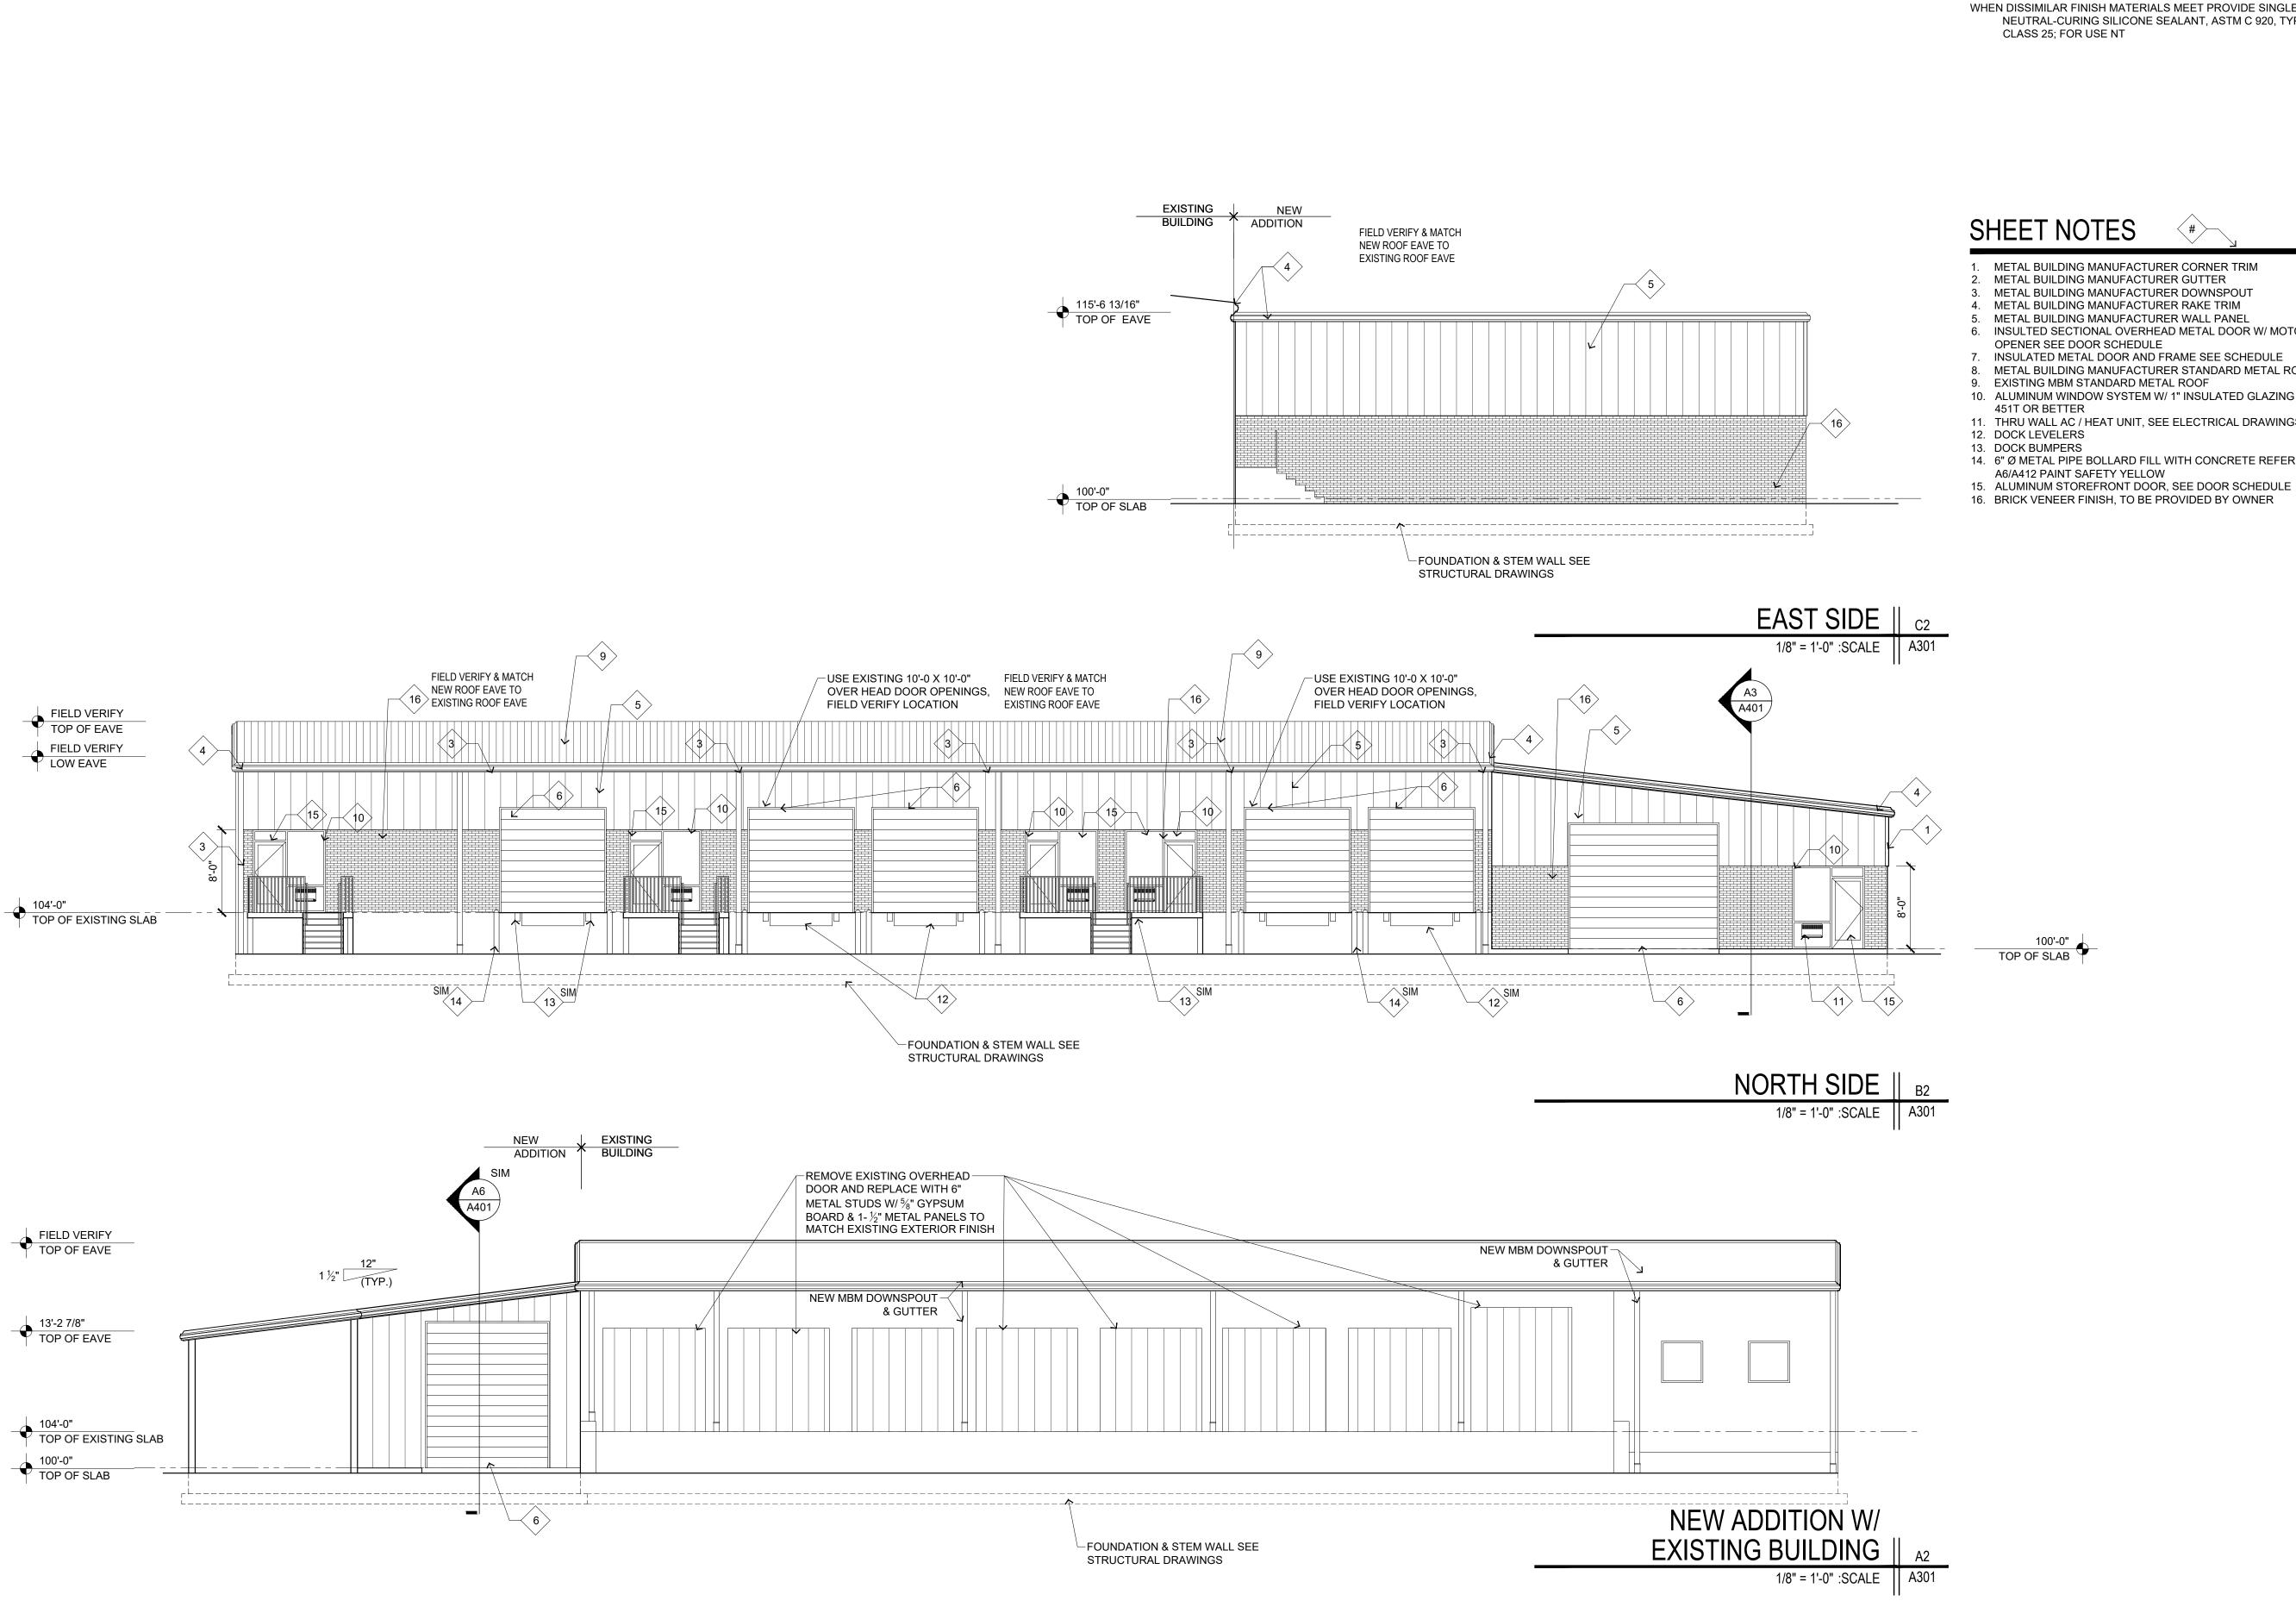
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GENERAL NOTES ELEVATIONS

ALL DIMENSIONS ARE FROM/TO FACE OF WALL FINISH TO FACE OF WALL

FINISH U N O. DO NOT SCALE DRAWINGS IF DIMENSIONS ARE IN QUESTION, THE CONTRACTOR SHALL BE RESPONSIBLE FOR OBTAINING

CLARIFICATION FROM THE ARCHITECT BEFORE CONTINUING WITH CONSTRUCTION. THE CONTRACTOR SHALL VERIFY ALL DIMENSIONS AND CONDITIONS AT THE SITE AND REPORT ANY DISCREPANCY TO THE ARCHITECT / OWNERS REPRESENTATIVE BEFORE PROCEED WITH

THE WORK. ALL SECTIONS, DETAILS, MATERIALS, METHODS, ETC SHOWN AND/OR NOTED ON ANY PLAN OR SECTION SHALL APPLY TO ALL OTHER SIMILAR CONDITIONS AND LOCATIONS UNLESS NOTED OTHERWISE.

REFER ARCHITECTURAL SHEET A500 FOR DOOR AND WINDOW SCHEDULES; REFER SHEET A500 FOR DOOR AND WINDOW ELEVATIONS.

ALL DISSIMILAR METALLIC MATERIALS SHALL BE EFFECTIVELY ISOLATED FROM EACH OTHER TO PREVENT GALVANIC ACTION.

WHEN DISSIMILAR FINISH MATERIALS MEET PROVIDE SINGLE-COMPONENT, NEUTRAL-CURING SILICONE SEALANT, ASTM C 920, TYPE S; GRADE NS;

- 5. METAL BUILDING MANUFACTURER WALL PANEL
- 6. INSULTED SECTIONAL OVERHEAD METAL DOOR W/ MOTORIZED
- 7. INSULATED METAL DOOR AND FRAME SEE SCHEDULE
- 8. METAL BUILDING MANUFACTURER STANDARD METAL ROOF PANELS
- 10. ALUMINUM WINDOW SYSTEM W/ 1" INSULATED GLAZING KAWNEER
- 11. THRU WALL AC / HEAT UNIT, SEE ELECTRICAL DRAWINGS
- 14. 6" Ø METAL PIPE BOLLARD FILL WITH CONCRETE REFER DETAIL

JOHNSON

EXTERIOR


1804


05.24.19

chk'd by drawn by JP

rev. by

A301

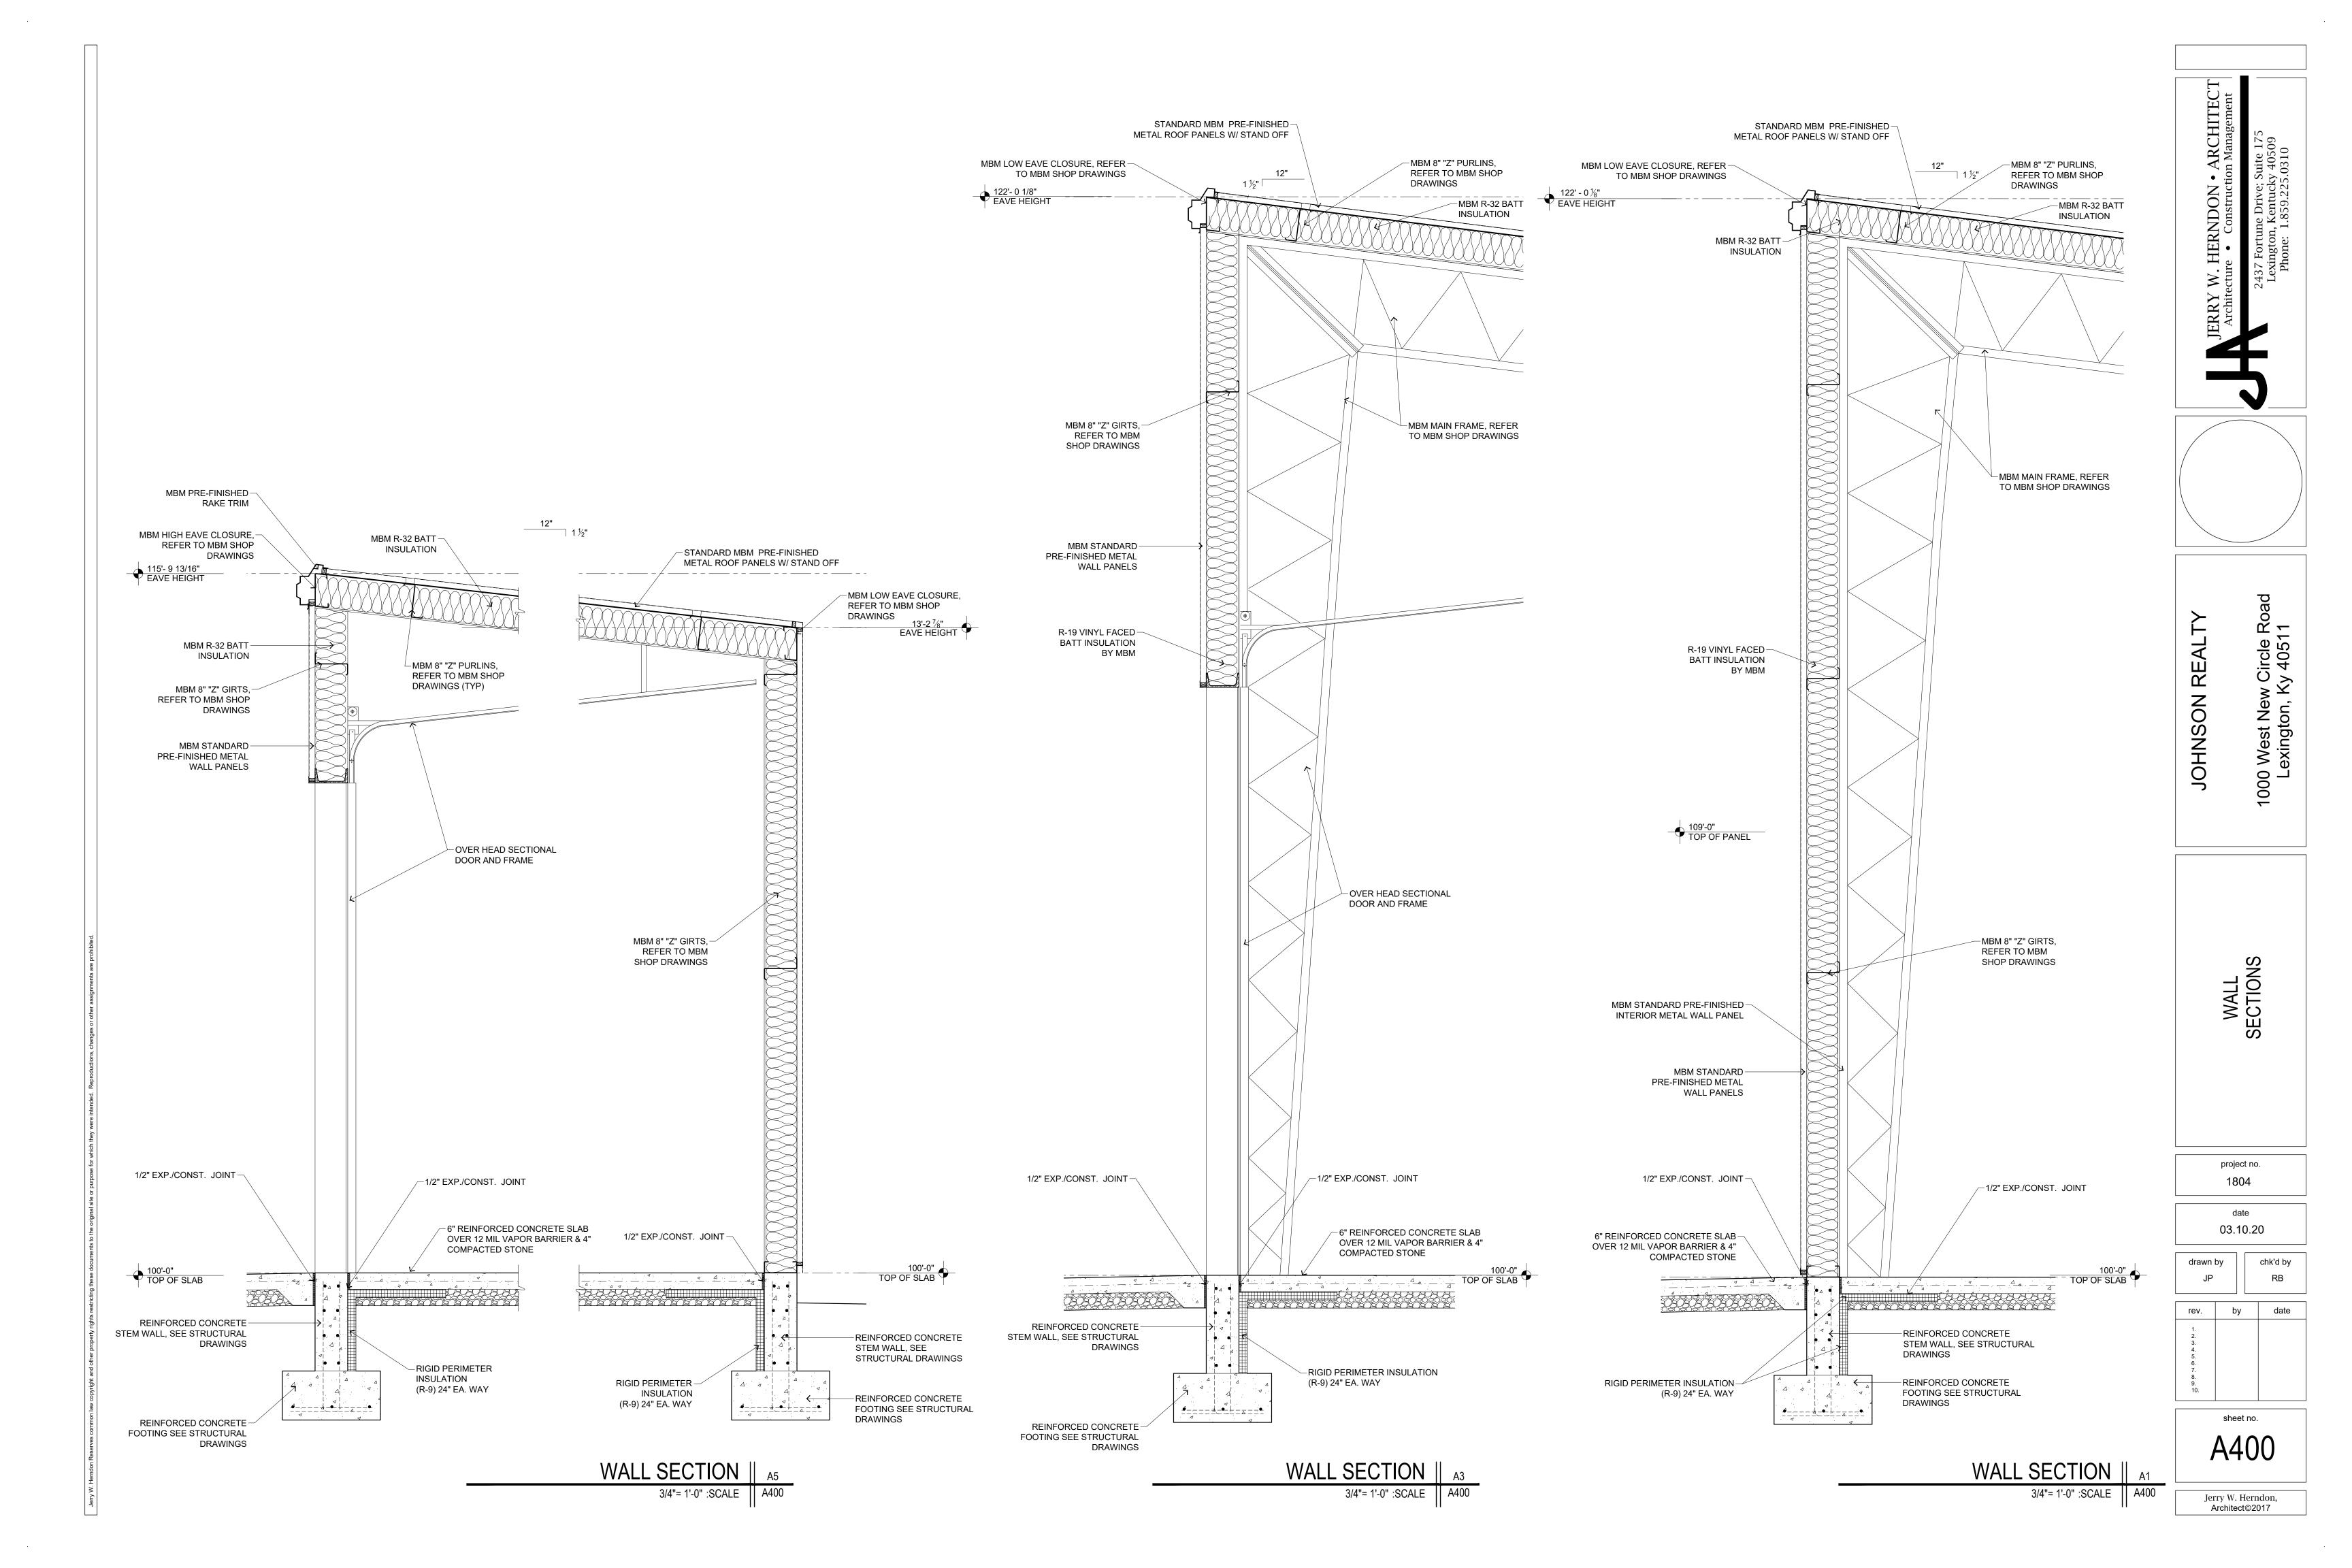

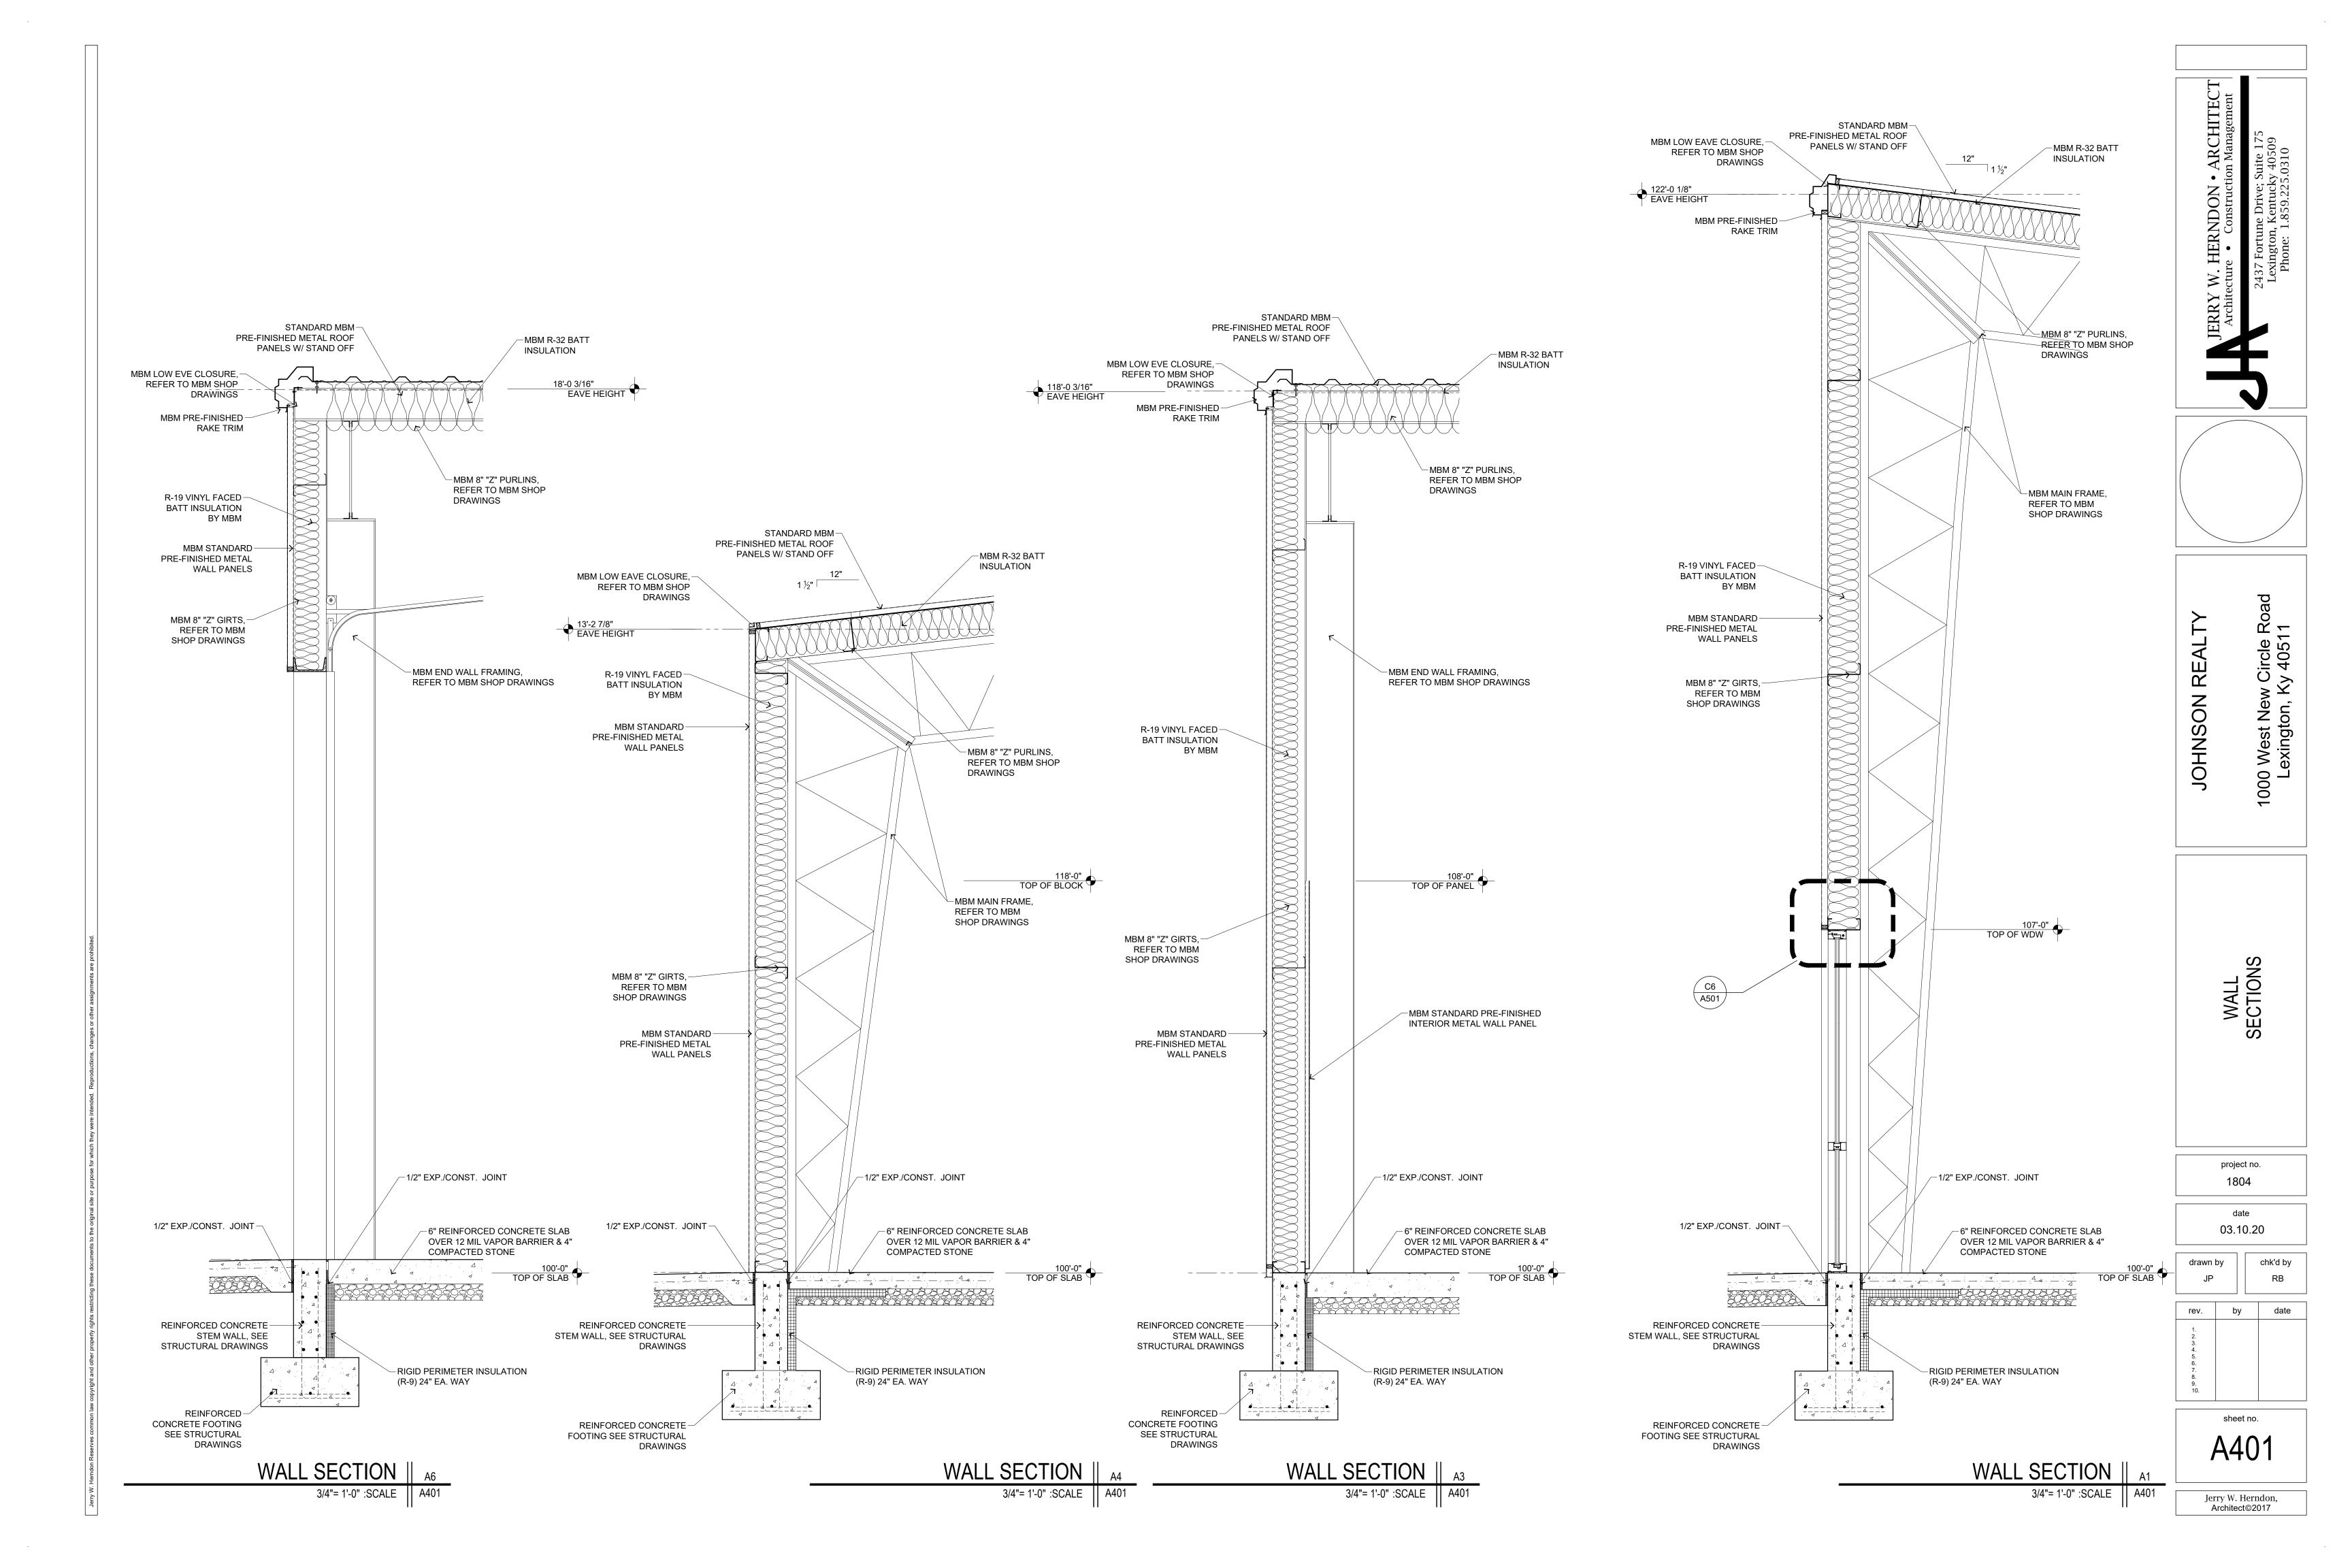

	SIZE		TY	PE	M/	MATERIAL FINISH DETAILS			DETAILS			ш	NOTES:		
DOOR NUMBER		THICK- NESS	DOOR	FRAME	DOOR	FRAME	GLAZ.	DOOR	FRAME	HEAD	JAMB	THRES.	RATING	HARDWARE SET NO.	
100a	144 x 144	1 3/4	D-2	F-2	STEEL	STEEL	-	DF-2	FF-1	B2/A501	B6/A501	-	-	-	-
100b	36 x 84	1 3/4	D-3	F-1	ALUM	ALUM	-	DF-1	FF-1	C5/A501	B5/A501	A2/A501	-	-	-
100c	36 x 84	1 3/4	D-1	F-1	НМ	НМ	-	DF-1	FF-1	C3/A501	C2/A501	-	-	-	-
100d	36 x 84	1 3/4	D-1	F-1	НМ	НМ	-	DF-1	FF-1	C3/A501	C2/A501	-	-	-	-
101a	144 x 144	1 3/4	D-2	F-2	STEEL	STEEL	-	DF-2	FF-1	B2/A501	B6/A501	-	ı	-	-
101b	36 x 84	1 3/4	D-3	F-1	ALUM	ALUM	-	DF-1	FF-1	C5/A501	B5/A501	A2/A501	-	-	-
101c	36 x 84	1 3/4	D-1	F-1	HM	HM	-	DF-1	FF-1	C3/A501	C2/A501	-	-	-	-
101d	36 x 84	1 3/4	D-1	F-1	HM	HM	-	DF-1	FF-1	C3/A501	C2/A501	-	-	-	-
102a	144 x 144	1 3/4	D-2	F-2	STEEL	STEEL	-	DF-2	FF-1	B2/A501	B6/A501	-	-	-	-
102b	36 x 84	1 3/4	D-3	F-1	ALUM	ALUM	-	DF-1	FF-1	C5/A501	B5/A501	A2/A501	-	-	-
102c	36 x 84	1 3/4	D-1	F-1	HM	HM	-	DF-1	FF-1	C3/A501	C2/A501	-	-	-	-
102d	36 x 84	1 3/4	D-1	F-1	HM	HM	-	DF-1	FF-1	C3/A501	C2/A501	-	-	-	-
103a	144 x 144	1 3/4	D-2	F-2	STEEL	STEEL	-	DF-2	FF-1	B2/A501	B6/A501	-	-	<u> </u>	-
103b	36 x 84	1 3/4	D-3	F-1	ALUM	ALUM	-	DF-1	FF-1	C5/A501	B5/A501	A2/A501	-	<u> </u>	-
103c	36 x 84	1 3/4	D-1	F-1	HM	HM	-	DF-1	FF-1	C3/A501	C2/A501	-	-	-	-
103d	36 x 84	1 3/4	D-1	F-1	HM	HM	-	DF-1	FF-1	C3/A501	C2/A501	-	-	-	-
104a	144 x 144	1 3/4	D-2	F-2	STEEL	STEEL	-	DF-2	FF-1	B2/A501	B6/A501	-	-	 -	-
104b	36 x 84	1 3/4	D-3	F-1	ALUM	ALUM	-	DF-1	FF-1	C5/A501	B5/A501	A2/A501	-	 -	-
104c	36 x 84	1 3/4	D-1	F-1	HM	HM	-	DF-1	FF-1	C3/A501	C2/A501	-	-	 -	-
104d	36 x 84	1 3/4	D-1	F-1	HM	HM	-	DF-1	FF-1	C3/A501	C2/A501	-	-	-	-
105a	144 x 144	1 3/4	D-2	F-2	STEEL	STEEL	-	DF-2	FF-1	B2/A501	B6/A501	-	-	-	-
105b	36 x 84	1 3/4	D-3	F-1	ALUM	ALUM	-	DF-1	FF-1	C5/A501	B5/A501	A2/A501	-	-	-
105c 105d	36 x 84 36 x 84	1 3/4	D-1 D-1	F-1 F-1	HM HM	HM HM	-	DF-1 DF-1	FF-1 FF-1	C3/A501	C2/A501 C2/A501	-	-	-	-
106a	144 x 120	1 3/4	D-1 D-2	F-2	STEEL	STEEL	-	DF-1 DF-2	FF-1	C3/A501 B2/A501	B6/A501	-	-	-	-
100a 107a	144 x 144	1 3/4	D-2	F-2	STEEL	STEEL	-	DF-2	FF-1	B2/A501	B6/A501	-	-	- _	 -
107a	36 x 84	1 3/4	D-3	F-1	ALUM	ALUM	_	DF-1	FF-1	C5/A501	B5/A501	Δ2/Δ501		 -	- -
107b	36 x 84	1 3/4	D-3	F-1	HM	HM	_	DF-1	FF-1	C3/A501	C2/A501	-		<u> </u>	_
107d	36 x 84	1 3/4	D-1	F-1	HM	HM	_	DF-1	FF-1	C3/A501	C2/A501	_	_	-	-
108a	144 x 144	1 3/4	D-2	F-2	STEEL	STEEL	_	DF-2	FF-1	B2/A501	B6/A501	_	_	+ -	_
108b	36 x 84	1 3/4	D-3	F-1	ALUM	ALUM	_	DF-1	FF-1	C5/A501	B5/A501	A2/A501	_	<u> </u>	-
108c	36 x 84	1 3/4	D-1	F-1	НМ	HM	_	DF-1	FF-1	C3/A501	C2/A501	-	-	-	-
108d	36 x 84	1 3/4	D-1	F-1	НМ	НМ	-	DF-1	FF-1	C3/A501	C2/A501	-	-	-	-
109a	120 x 120	1 3/4	D-2	F-2	STEEL	STEEL	-	DF-2	FF-1	B2/A501	B6/A501	-	-	-	-
109b	120 x 120	1 3/4	D-2	F-2	STEEL	STEEL	-	DF-2	FF-1	B2/A501	B6/A501		-	-	-
109c	36 x 84	1 3/4	D-3	F-1	ALUM	ALUM	-	DF-1	FF-1	D2/A501	D3/A501	A2/A501	-	-	_
109d	36 x 84	1 3/4	D-1	F-1	НМ	НМ	-	DF-1	FF-1	C3/A501	C2/A501	-	-	-	
110a	120 x 120	1 3/4	D-2	F-2	STEEL	STEEL	-	DF-2	FF-1	B2/A501	B6/A501	-	-	-	-
110b	36 x 84	1 3/4	D-3	F-1	ALUM	ALUM	-	DF-1	FF-1	D2/A501	D3/A501	A2/A501	•	-	-
110c	36 x 84	1 3/4	D-1	F-1	НМ	НМ	-	DF-1	FF-1	C3/A501	C2/A501	-	-	-	-
111a	120 x 120	1 3/4	D-2	F-2	STEEL	STEEL	-	DF-2	FF-1	B2/A501	B6/A501	-	-	-	-
111b	36 x 84	1 3/4	D-3	F-1	ALUM	ALUM	-	DF-1	FF-1	D2/A501	D3/A501	A2/A501	-	-	-
111c	36 x 84	1 3/4	D-1	F-1	НМ	HM	-	DF-1	FF-1	C3/A501	C2/A501	-	-	-	-
112a	120 x 120	1 3/4	D-2	F-2	STEEL	STEEL	-	DF-2	FF-1	B2/A501	B6/A501	-	-	<u> </u>	-
112b	36 x 84	1 3/4	D-3	F-1	ALUM	ALUM	-	DF-1	FF-1	D2/A501	D3/A501	A2/A501	-	-	-
112c	36 x 84	1 3/4	D-1	F-1	HM	HM	-	DF-1	FF-1	C3/A501	C2/A501	-	-	-	-

DOC	OR / FRAME FINISH KEY	WINDOW SCHEDULE												
DF-1 DF-2	PAINT FACTORY FINISH				SIZE		MATL. FINISH		DETAILS			NOTES:		
FF-1	PAINT	WINDOW	TYPE	# OF LITES	WIDTH (R.O.)	HEIGHT (R.O.)	FRAME	GLAZ.	EXT.	NT.	HEAD	JAMB	SILL	
		100A	W-1	3	84"	96"	Alum	G-1	F-1	F-1	C4/A501	B4/A501	-	-
		101A	W-1	3	84"	96"	Alum	G-1	F-1	F-1	C4/A501	B4/A501	-	-
		102A	W-1	3	84"	96"	Alum	G-1	F-1	F-1	C4/A501	B4/A501	-	-
		103A	W-1	3	84"	96"	Alum	G-1	F-1	F-1	C4/A501	B4/A501	-	-
		104A	W-1	3	84"	96"	Alum	G-1	F-1	F-1	C4/A501	B4/A501	-	-
		105A	W-1	3	84"	96"	Alum	G-1	F-1	F-1	C4/A501	B4/A501	-	-
		107A	W-1	3	84"	96"	Alum	G-1	F-1	F-1	C4/A501	B4/A501	-	-
		108A	W-1	3	84"	96"	Alum	G-1	F-1	F-1	C4/A501	B4/A501	-	-
		109A	W-1	3	84"	96"	Alum	G-1	F-1	F-1	D4/A501	D6/A501	D5/A501	-
		110A	W-1	3	84"	96"	Alum	G-1	F-1	F-1	D4/A501	D6/A501	D5/A501	-
		111A	W-1	3	84"	96"	Alum	G-1	F-1	F-1	D4/A501	D6/A501	D5/A501	-
		112A	W-1	3	84"	96"	Alum	G-1	F-1	F-1	D4/A501	D6/A501	D5/A501	-

GLASS & GLAZING KEY (G-*)

WINDOW FINISH KEY

G-1 1" INSULATED GLAZING W/ LOW "E" COATING MIN. U VALUE 0.32, MIN. SHGC 0.6 (COOL GRAY TENT)

F-1 ANODIZED ALUMINUM

GENERAL NOTES DOORS

ALL DOOR HARDWARE SHALL COMPLY WITH ADA REQUIREMENTS, IBC 2012 AND THE KENTUCKY BUILDING CODE 2013. TYPE OF DOOR LOCK SETS SHALL BE APPROPRIATE FOR THE TYPE / INTENDED USE FOR THE ROOM / SPACE. LATCHING AND LOCKING DOORS THAT ARE HAND-ACTIVATED AND WHICH ARE IN A PATH OF TRAVEL SHALL BE OPERABLE WITH A SINGLE EFFORT BY PANIC BARS, PUSH-PULL ACTIVATING BARS OR OTHER HARDWARE DESIGNED TO PROVIDE PASSAGE WITHOUT REQUIRING THE ABILITY TO GRASP THE OPENING HARDWARE. LOCKED EXIT DOORS SHALL OPERATE AS ABOVE IN THE EGRESS

DIRECTION. ALL DOORS FROM OCCUPIED SPACES AND EXIT DOORS FROM THE FACILITY SHALL BE OPERABLE FORM THE INSIDE WITHOUT THE USE OF A KEY OR SPECIAL KNOWLEDGE AND SHALL NOT REQUIRE TIGHT GRASPING, PINCHING, OR

TWISTING OF THE WRIST TO OPERATE. MANUAL FLUSH BOLTS SHALL NOT BE USED ON DOUBLE DOORS IN EGRESS PATH

(EXIT DOORS). ALL HARDWARE SHALL BE COMMERCIAL GRADE STANDARD DUTY UNLESS HARDWARE FUNCTION REQUIRES HEAVY DUTY GRADE.

HARDWARE FINISH SHALL BE SELECTED BY THE OWNER OR HIS REPRESENTATIVE. ALL DOOR FRAMES SHALL RECEIVE DOOR SILENCERS EXCEPT FOR EXTERIOR DOORS WHICH SHALL RECEIVE BULB TYPE WEATHER STRIPPING ALL EXTERIOR DOORS SHALL RECEIVE ADA COMPLIANT THRESHOLDS.

ALL EXTERIOR DOORS SHALL RECEIVE DOOR CLOSURES. ALL DOORS IN CORRIDORS AND STORAGE ROOMS DOORS SHALL RECEIVE CLOSERS. ALL DOOR CLOSER SHALL HAVE COVERS AND SHALL MEET ADA REQUIREMENTS. STORAGE ROOM, AND MECHANICAL ROOM DOORS SHALL HAVE 32" X 12"

STAINLESS STEEL KICK PLATES ON PUSH SIDE OF DOORS. MAXIMUM EFFORT TO OPERATE DOORS SHALL NOT EXCEED THE FOLLOWING: INTERIOR DOORS: 5 POUNDS


EXTERIOR DOORS: 8.5 POUNDS FIRE DOORS: 15 POUNDS LEGAL EXITS SHALL NOT BE BLOCKED AT ANY TIME.

ALL HOLLOW METAL SMOKE CONTROL DOOR ASSEMBLIES SHALL COMPLY WITH NFPA 105 AND/OR UL 1784. ALL INTERIOR HM DOORS SHALL BE STANDARD DUTY, LEVEL 1, PHYSICAL PERFORMANCE U.N.O.

ALL EXTERIOR HM DOORS SHALL BE HEAVY DUTY, LEVEL 2, PHYSICAL PERFORMANCE B WITH R VALUE OF 15 U.N.O. ALL INTERIOR HM DOOR FRAMES SHALL BE KNOCK DOWN, 0.042" METAL


THICKNESS ALL EXTERIOR HM DOORS SHALL BE MITERED OR COPED WITH CONTINUOUS WELD, 0.053" METAL THICKNESS.


HARDWARE REINFORCING SHALL COMPLY WITH ANSI/SDI A250.6 AND MINIMUM THICKNESS FOR FRAME ANCHOR SHALL BE 0.42" THICK.

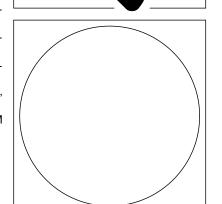

ROOM FINISH NOTES:

PAINT ALL GYPSUM BOARD

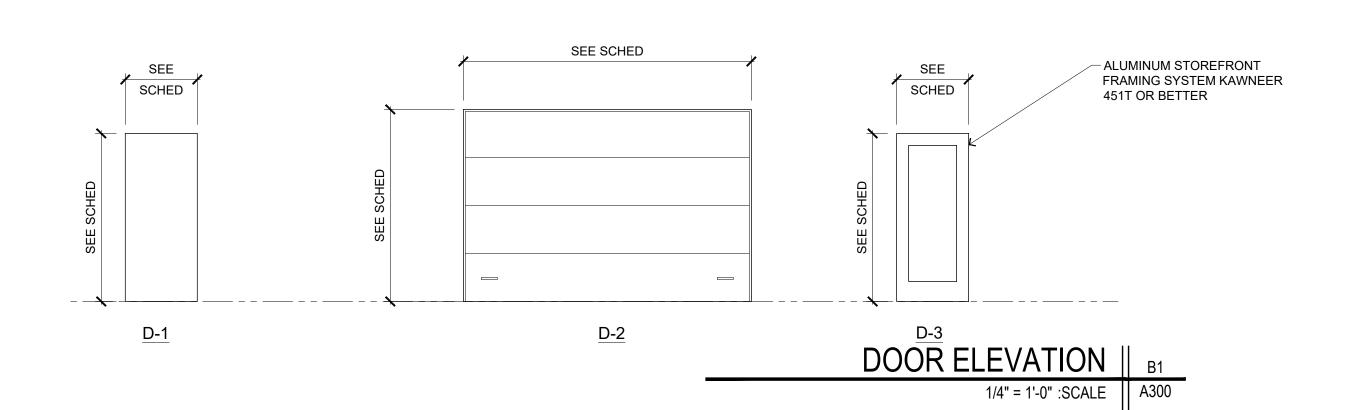

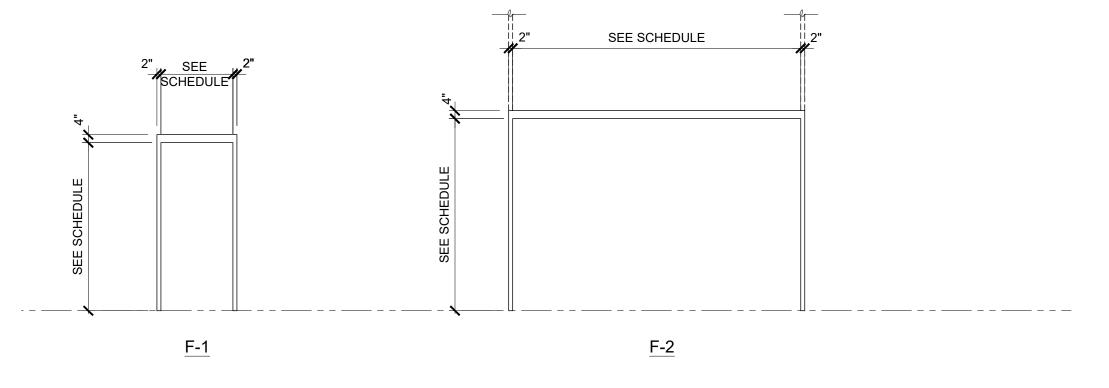

— ALUMINUM STOREFRONT FRAMING SYSTEM KAWNEER 451T OR BETTER G-2 <u>W-1</u>

DOOR FRAME ELEVATION | A5

WINDOW FRAME ELEVATION |


JOHNSON


DOOR SCHEDULES AND DETAILS

1804

03.10.20

drawn by JP

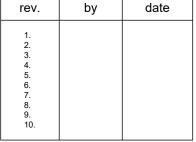

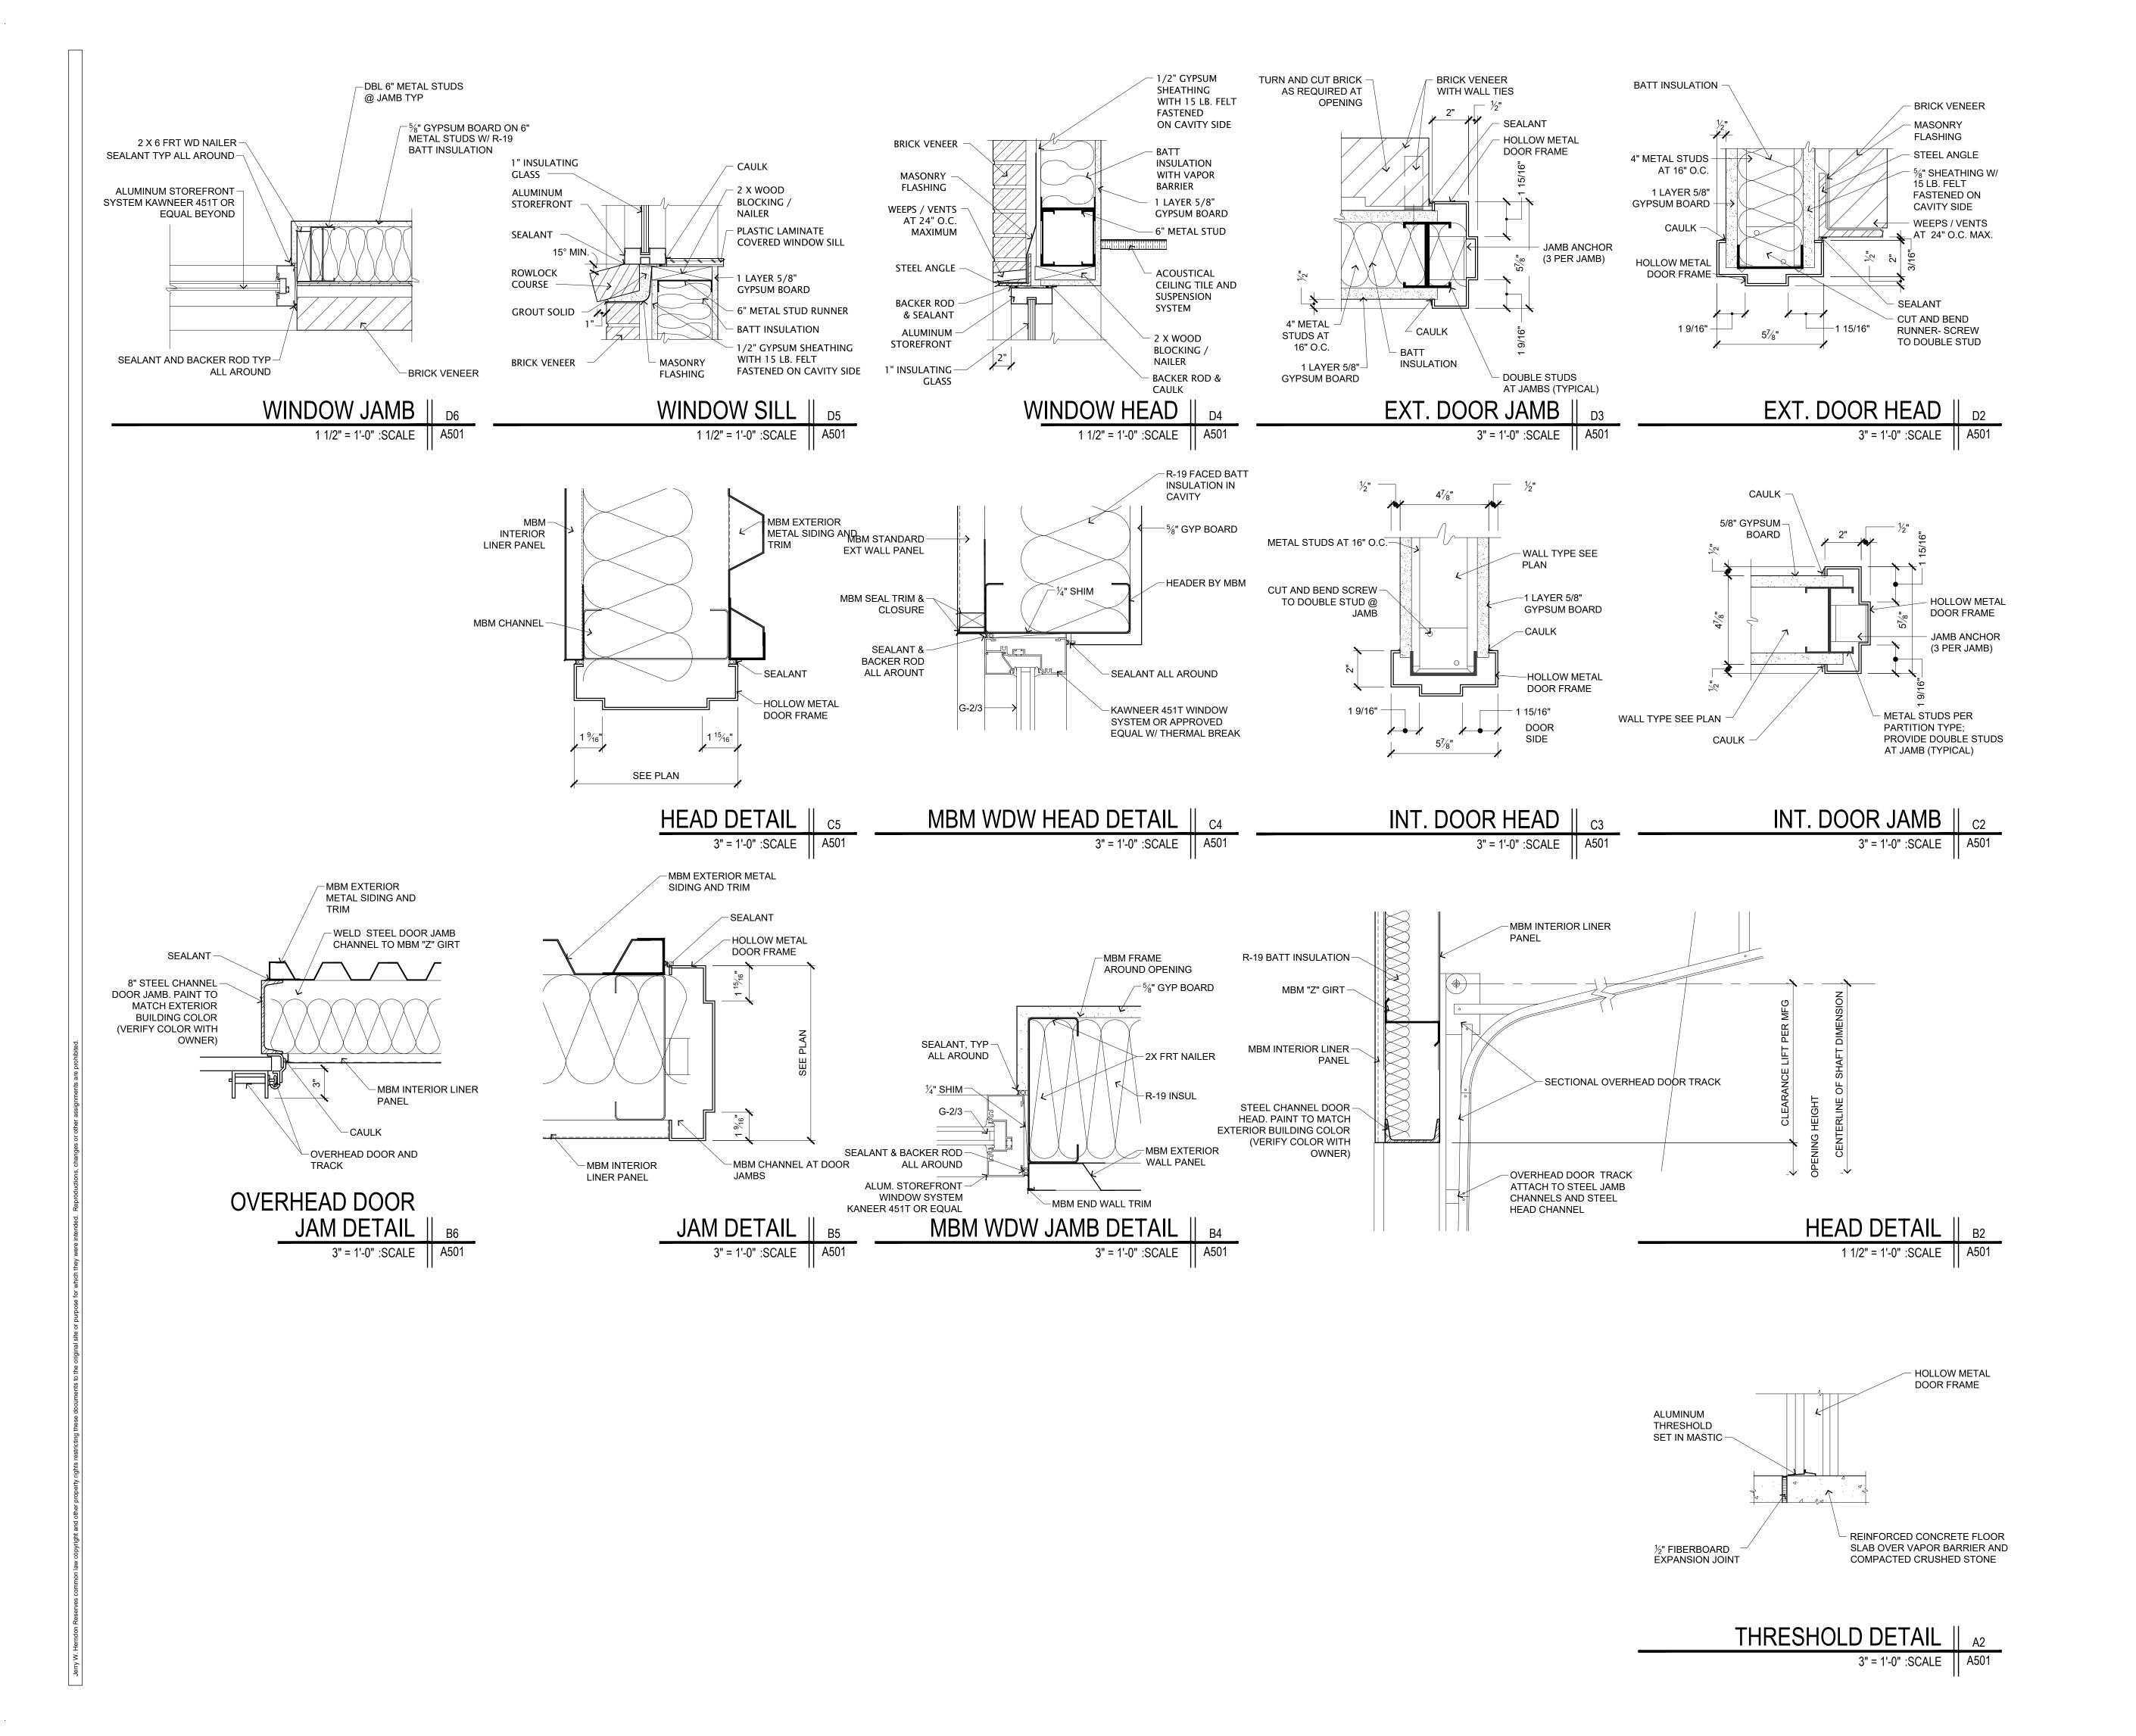

JOHNSON REALTY

1000 West New Circle Road Lexington, Ky 40511

project no. 1804

date 03.10.20

chk'd by drawn by JP

rev. by

A501